Infrastructure Upgrades

Saint Joseph Public Schools
Saint Joseph, MI

Project Number: SJPS2304-0300

Saint Joseph Public Schools Infrastructure Upgrades Saint Joseph, MI

ISSUE / DATE
2023-12-22 BIDS

DRAWN BY
CDB
PROJECT NO.
SJPS2304-0300

TG01

			CABLIN	G AND JA	CK LEGENI)				
PURPOSE	PREMISE CABLING					JACKS				
	COLOR	RATING	MANUFACTURER	MODEL	TR COLOR	WA COLOR	MANUFACTURER	MODEL	SHIELDED	
COPPER BACKBONE					RED	RED		CJ688TGRD	CJS688TGRDY	
RESERVED					ORANGE	ORANGE		CJ688TGOR		
WIRELESS ACCESS POINTS		PLENUM	GENERAL CABLE	GENSPEED 6000	YELLOW	YELLOW	PANDUIT	CJ688TGYL	CJS688TGYLY	
FACILITIES					GREEN	GREEN		CJ688TGGR	CJS688TGGRY	
SPECIAL NETWORK	BLUE				BLUE	BLUE		CJ688TGBU	CJS688TGBUY	
SURVEILLANCE CAMERAS					VIOLET	VIOLET		CJ688TGVL	CJS688TGVLY	
RESERVED					BACK	BLACK		CJ688TGBL	CJS688TGY	
POTS LINES					GRAY	GRAY		CJ688TGIG		
GENERAL PURPOSE					WHITE	WHITE	1	CJ688TGWH	CJS688TGWHY	

FIBER LEGEND										
PURPOSE	TYPE	RATING	MANUFACTURER	MODEL						
DUTSIDE PLANT	OUTSIDE PLANT	N/A	GENERAL CABLE	AQ***4M1A-DT						
BACKBONE	INDOOR/OUTDOOR	PLENUM	GENERAL CABLE	AP***1ANU.BK						

	MANUFACTURER	MODEL			
	GENERAL CABLE	AQ***4M1A-DT			
	GENERAL CABLE	AP***1ANU.Bł	<		
PA	TCH CORE	LEG	END		
	PURPOSE	TR	WORK AREA		
		COLOR			
GENERA	AL DATA	WHITE			
WIRELE	SS ACCESS POINTS	YELLOW			
FACILITIES		GREEN			
SURVEILLANCE CAMERAS		VIOLET			
PAGING		WHITE			
AV		WHITE			

DESCRIPTION	ABBREVIATION
	AC
STING	AFF
	ATS
	AV OR A/V
CEPTACLE	BAS
ND	BB
	CIP
ECTION	CLG
EETION	СР
TION	EC
RK	EF
	EMT
45)	EQ
	EQUIV
	ER
	EXIST
	GFCI
	GRD
	НС
UDIO	IC
10	MC
	NIC
	ОС
	OSP
	PBB
	PT
	RBC
	SBB
	SC

ABBREVIATIONS

ACCESS CONTROL

ABOVE FINISH FLOOR

AUDIO / VIDEO

BACKERBOARD

CAST IN PLACE

CONSOLIDATION POINT

ENTRANCE FACILITY

EQUIVALENT

EXISTING

GROUND

EQUIPMENT ROOM

ELECTRICAL CONTRACTOR

ELECTRICAL METALLIC TUBING

GROUND FAULT CIRCUIT INTERRUPTER

HORIZONTAL CROSS-CONNECT

INTERMEDIATE CROSS-CONNECT

MAIN CROSS-CONNECT

NOT IN CONTRACT

ON CENTER

OUTSIDE PLANT

POKE-THROUGH

PRIMARY BONDING BUSBAR

RACK BONDING CONDUCTOR

SECONDARY BONDING BUSBAR

STRUCTURED CABLING CONTRACTOR

TELECOMMUNICATIONS ENCLOSURE

TELECOMMUNICATIONS OUTLET

TELECOMMUNICATIONS ROOM

UNLESS NOTED OTHERWISE

UNINTERRUPTIBLE POWER SUPPLY

TYPICAL

WORK AREA

TELECOMMUNICATIONS BONDING BACKBONE

TELECOMMUNICATIONS EQUIPMENT BONDING CONDUCTOR

STRUCTURED CABLING

AUTOMATIC TRANSFER SWITCH

BUILDING AUTOMATION SYSTEM

TERMINOLOGY

RISER LEGEND

ZONE OR AREA

BY OTHERS OR EXISTING

PLUG INTO 120V RECEPTACLE

CONNECT TO GROUND

GENERIC RF CONNECTION

BLUETOOTH CONNCETION

CELLULAR CONNECTION

8P8C (RJ45) NETWORK

KEYED 8P8C (RJ45)

SHIELDED 8P8C (RJ45)

COMPONENT VIDEO

COMPOSITE VIDEO

HD15 (VGA) VIDEO

RED & WHITE RCA AUDIO

3.5MM STEREO AUDIO

1/4" STEREO AUDIO

XLR MICROPHONE

COAX TYPE "F"

NEUTRIK NL4MP

CLOSET ID (A TO Z)

- RACK ID (1 OR 2 DIGITS)

- PATCH PANEL ID (A TO Z)

JACK NUMBER (01 TO 48)

DVI VIDEO

HDMI VIDEO

WIFI CONNECTION

SYMBOL


NUMBER	TITLE
TG01	Title Sheet
TG02	Technology General Information
T101	Brown ES Technology Plan - Composite
T102	E.P. Clarke ES Technology Plan - Composite
T103	Lincoln ES First Floor Technology Plan - Composite
T104A	Upton MS Technology Plan - Unit A
T104B	Upton MS Technology Plan - Unit B
T105	Saint Joseph HS Lower Floor Technology Plan
T106A	Saint Joseph HS Main Floor Technology Plan - Unit D
T106B	Saint Joseph HS Main Floor Technology Plan - Unit F & 0
T301	Structured Cabling General Information
T302	Tech Rack Elevations
T303	Tech Rack Elevations
T304	Tech Rack Elevations
T305	Tech Rack Elevations
T306	Structured Cabling Details & Risers
T307	Structured Cabling Support Information
T308	Network Diagram

GENERAL NOTES

- FOR DROPS INSTALLED ABOVE ACCESSIBLE CEILING, PROVIDE MAINTENANCE LOOP AS INDICATED ON TECHNOLOGY SYMBOL LEGEND. CABLE SHALL BE NEATLY COILED IN AN "S" LOOP AND SECURED TO BUILDING STRUCTURE AT DROP LOCATION FOR EASY RELOCATION.
- LOAD THE LATEST AVAILABLE STABLE FIRMWARE FOR ALL DEVICES WHEN THEY ARE SUPPLIED FOR THIS PROJECT.


LABEL CABLES ACCORDING TO "CABLING LABEL DETAIL" ON THIS PAGE.


IN THE EVENT OF A DISCREPANCY BETWEEN TECHNOLOGY PLANS AND OTHER DISCIPLINES, CONTRACTOR SHALL SUBMIT AN RFI FOR CLARIFICATION.

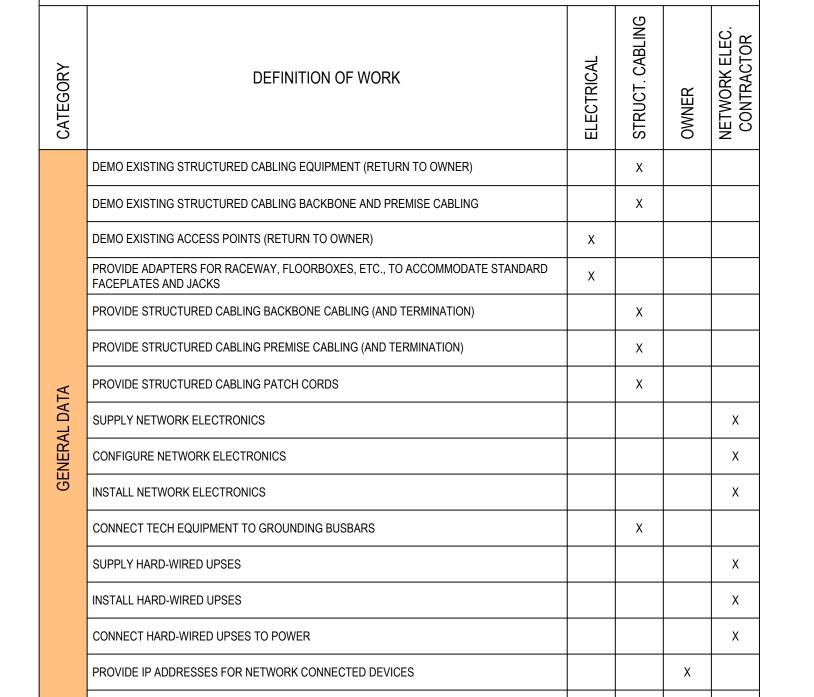



CONFIGURE VLANS


WORK SCOPE LEGEND

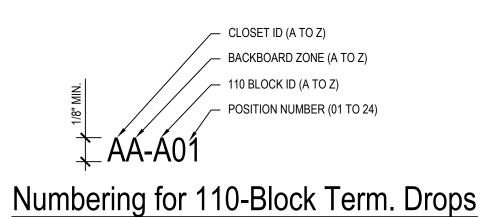

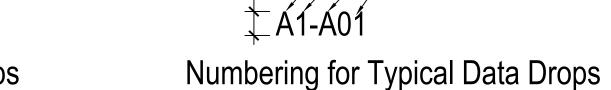

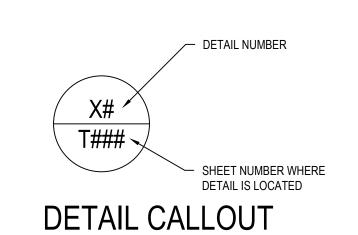

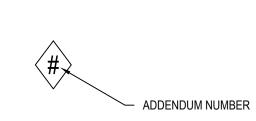


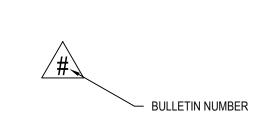


ADDENDUM TAG

LOCATED NEXT TO A REVISION CLOUD FOR ANY REVISIONS AFTER BIDS HAVE BEEN RELEASED, BEFORE CONTRACT HAS BEEN AWARDED.



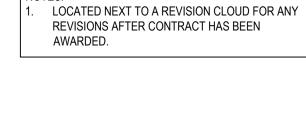


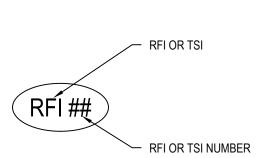


USED ON TECHNOLOGY FLOOR PLANS TO

REFERENCE A DETAIL, ELEVATION, OR SYSTEM

OF COMPONENTS ELEVATION ON ANOTHER

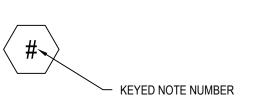

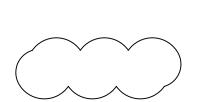


RFI OR TSI TAG

KEYED NOTE TAG


REVISION CLOUD


RFI (REQUEST FOR INFORMATION) INDICATES A REVISION AND CORRESPONDING NOTE THAT DOES NOT AFFECT BUDGET THAT WAS NOT INITIATED BY TECHNOLOGY CONTRACTOR. TSI (TECHNOLOGY INFORMATION) TAG INDICATES A REVISION AND CORRESPONDING


NOTE THAT DOES NOT AFFECT BUDGET.

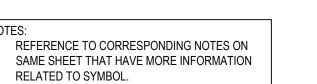


DRAWN AROUND REVISION AREA RELATED TO ANY ADDENDUM OR BULLETIN.

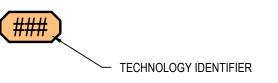

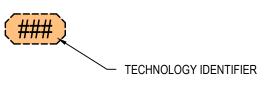

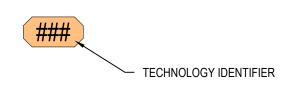

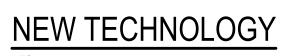

HEAVY SOLID LINE REPRESENTS NEW

TECHNOLOGY. COMPLETE INSTALLATION

FACEPLATE AND/OR DEVICE. SEE DRAWINGS


OFTEN REQUIRES ROUGH-IN, CABLING,

FOR MORE DETAIL.


DEMO TECHNOLOGY

MORE DETAIL.

HEAVY DASHED LINE REPRESENTS EXISTING TECHNOLOGY TO BE REMOVED. COULD REQUIRE DEMOLITION OF ROUGH-IN, CABLING, FACEPLATE AND/OR DEVICE. DEVICE MAY NEED TO BE SALVAGED FOR REINSTALLATION OR TURNED OVER TO OWNER. SEE DRAWINGS FOR

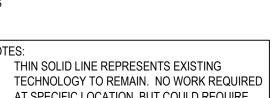

AT SPECIFIC LOCATION, BUT COULD REQUIRE EXISTING CABLING AND/OR DEVICES TO BE MAINTAINED DURING CONSTRUCTION TO SUPPORT SPECIFIC DEVICE. SEE DRAWINGS FOR MORE DETAIL.

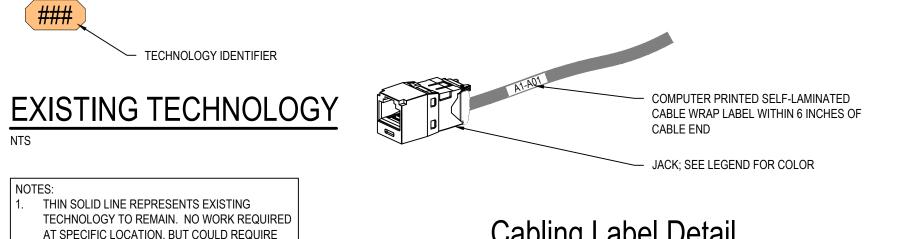

General Information Saint Joseph Public Schools Infrastructure Upgrades Saint Joseph, MI echnology

ISSUE / DATE 2023-12-22 BIDS ----------------DRAWN BY CDB PROJECT NO.

SJPS2304-0300 SHEET NO.

FLOOR PLANS ARE NOT PROVIDED FOR THE CENTRAL OFFICE, TRANSPORTATION BUILDING, PRESSBOX, AND STADIUM.




Brown ES Technology Plan - Composite

1/16" = 1'-0"

Saint Joseph Public Schools Infrastructure Upgrades Saint Joseph, MI ISSUE / DATE 2023-12-22 BIDS ----------------DRAWN BY

CDB PROJECT NO. SJPS2304-0300 SHEET NO.

T101

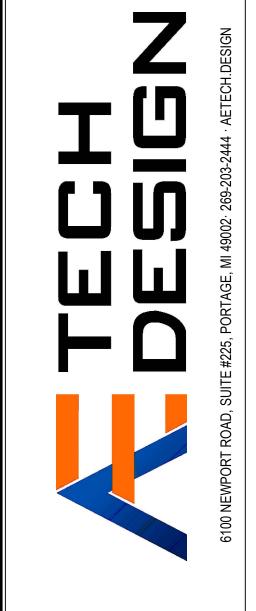


Saint Joseph Public Schools Infrastructure Upgrades Saint Joseph, MI

ISSUE / DATE 2023-12-22 BIDS ------------

----DRAWN BY CDB PROJECT NO.

SJPS2304-0300 SHEET NO.

T102

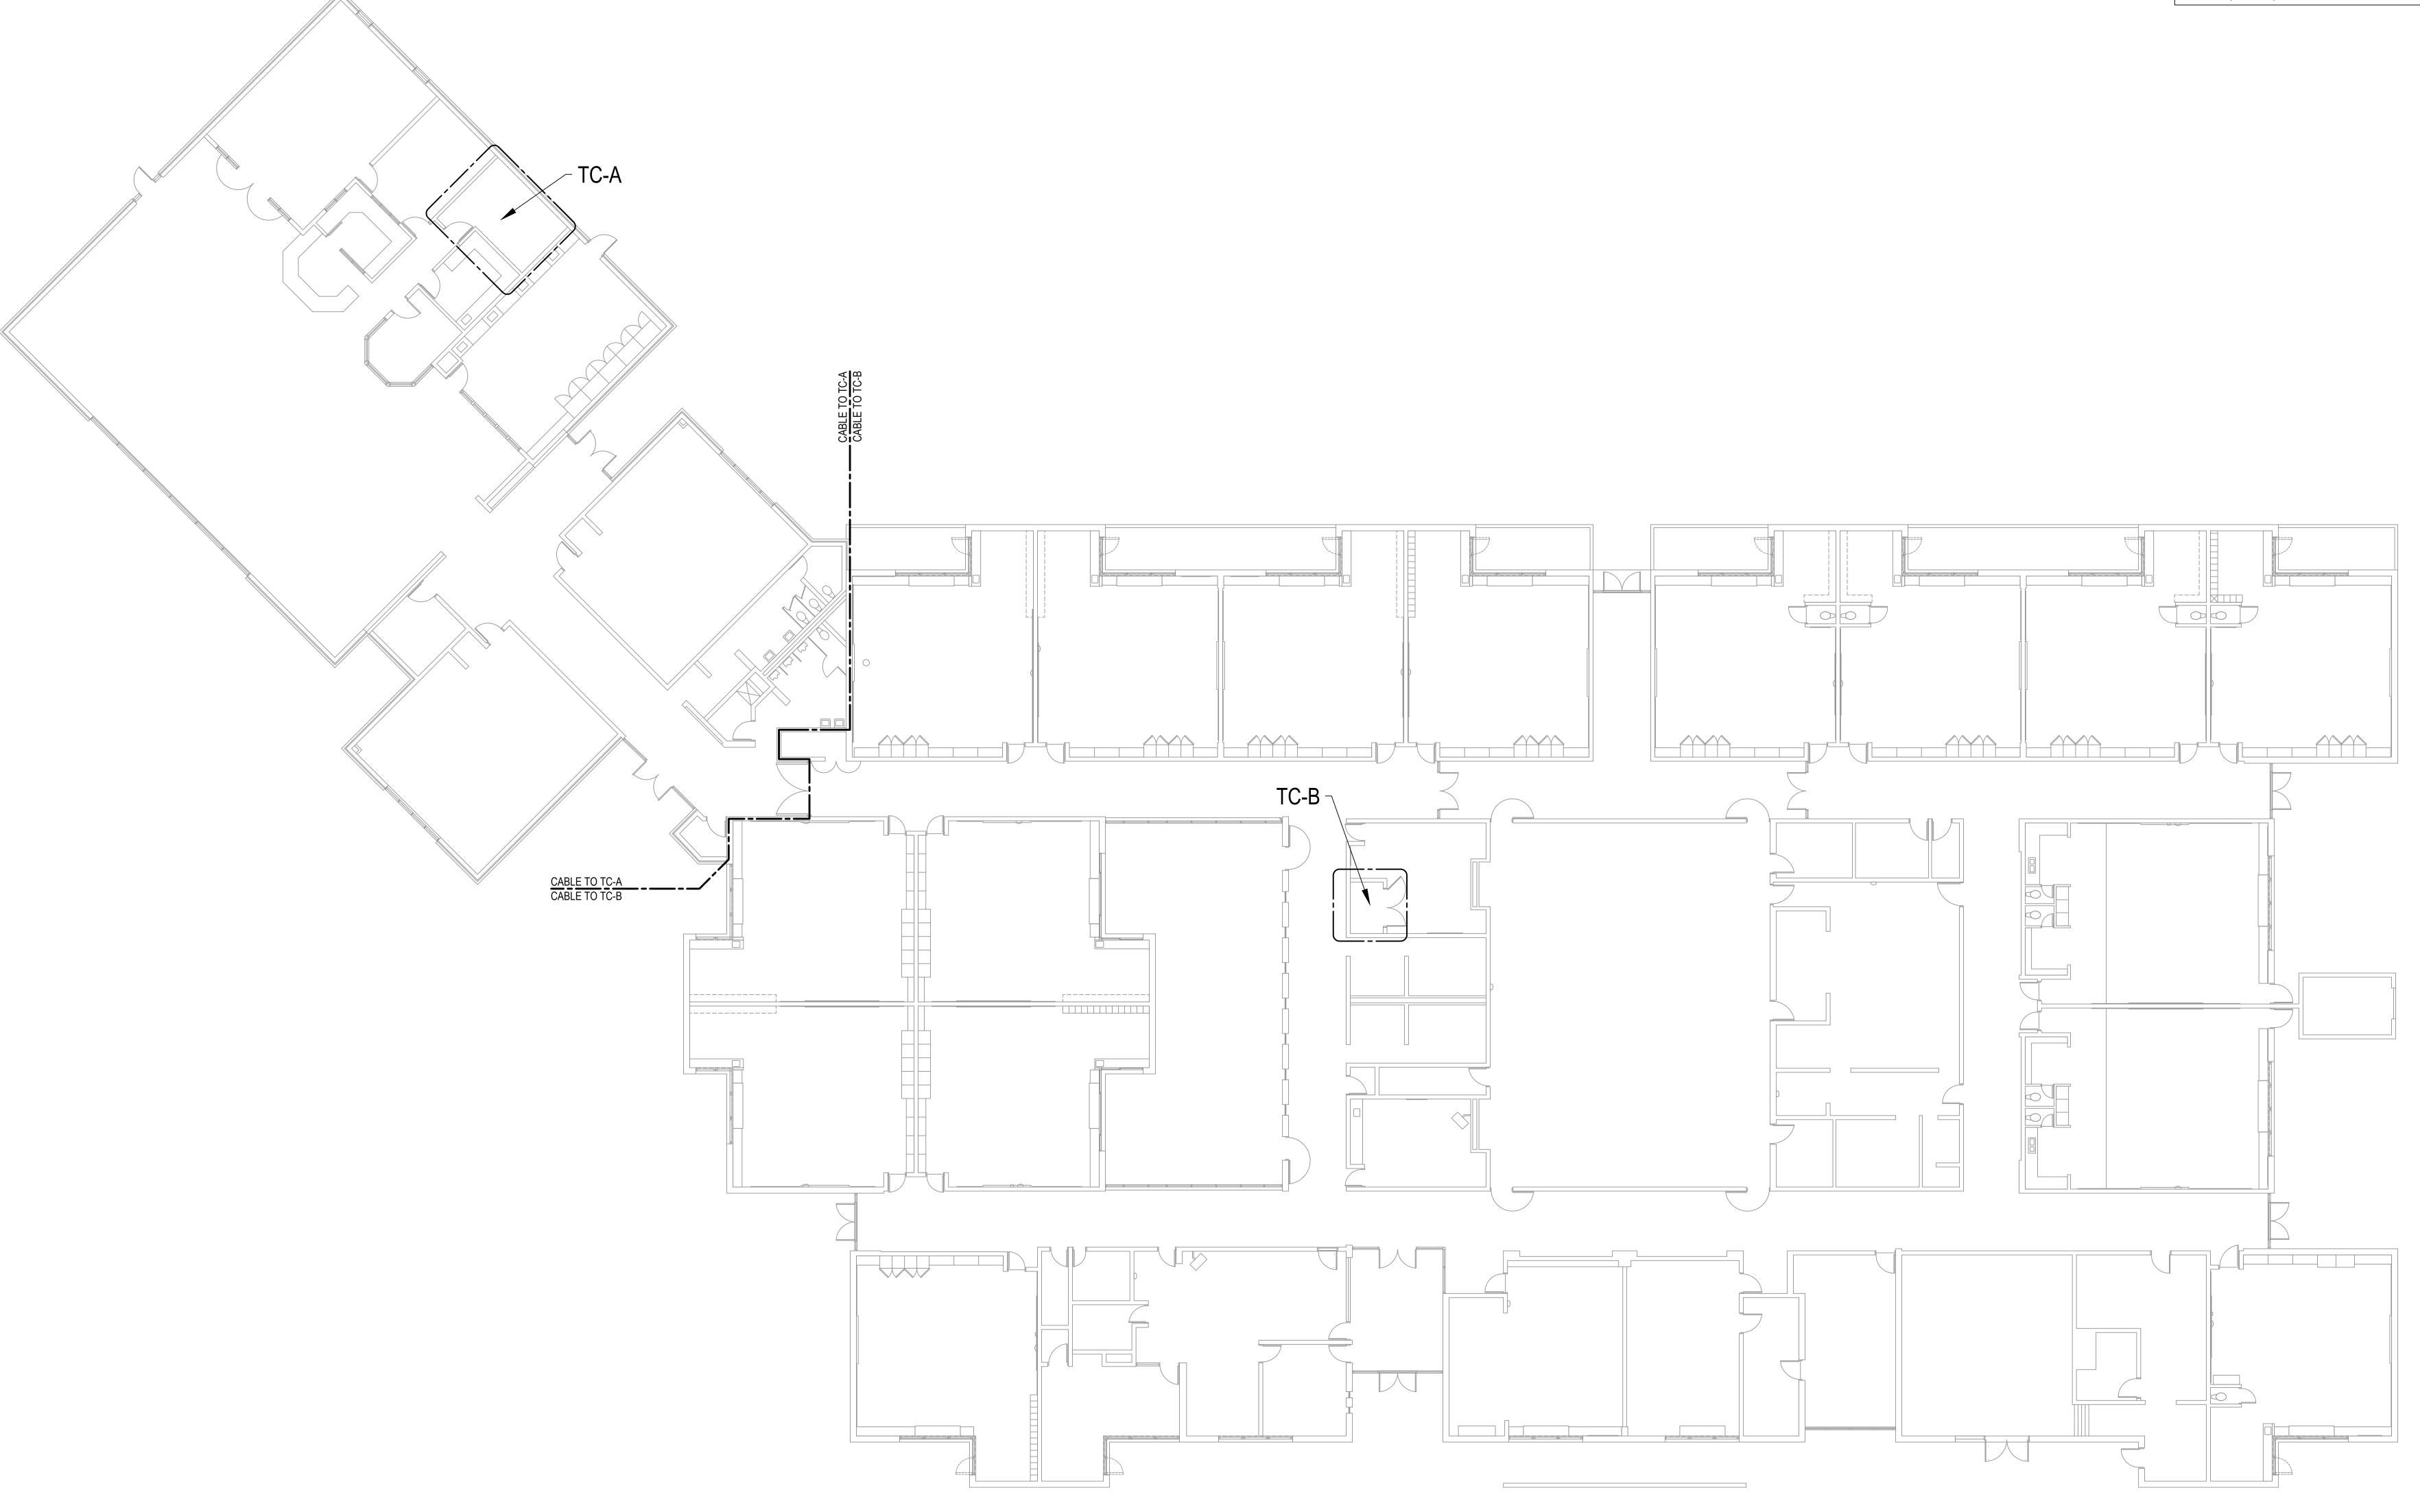

DEMO GENERAL NOTES

- DEMO ALL ABANDONED CABLES BACK TO THEIR SOURCE.
- DEMOED EQUIPMENT, WHOLE OR IN PART, SHALL BE PRESENTED TO OWNER FOR FIRST RIGHT OF REFUSAL BEFORE REMOVAL FROM SITE.
- FLOOR PLANS ARE NOT PROVIDED FOR THE CENTRAL OFFICE, TRANSPORTATION BUILDING, PRESSBOX, AND STADIUM.

Saint Joseph Public Schools Infrastructure Upgrades Saint Joseph, MI

ISSUE / DATE 2023-12-22 BIDS ------------

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Saint Joseph Public Schools Infrastructure Upgrades Saint Joseph, MI

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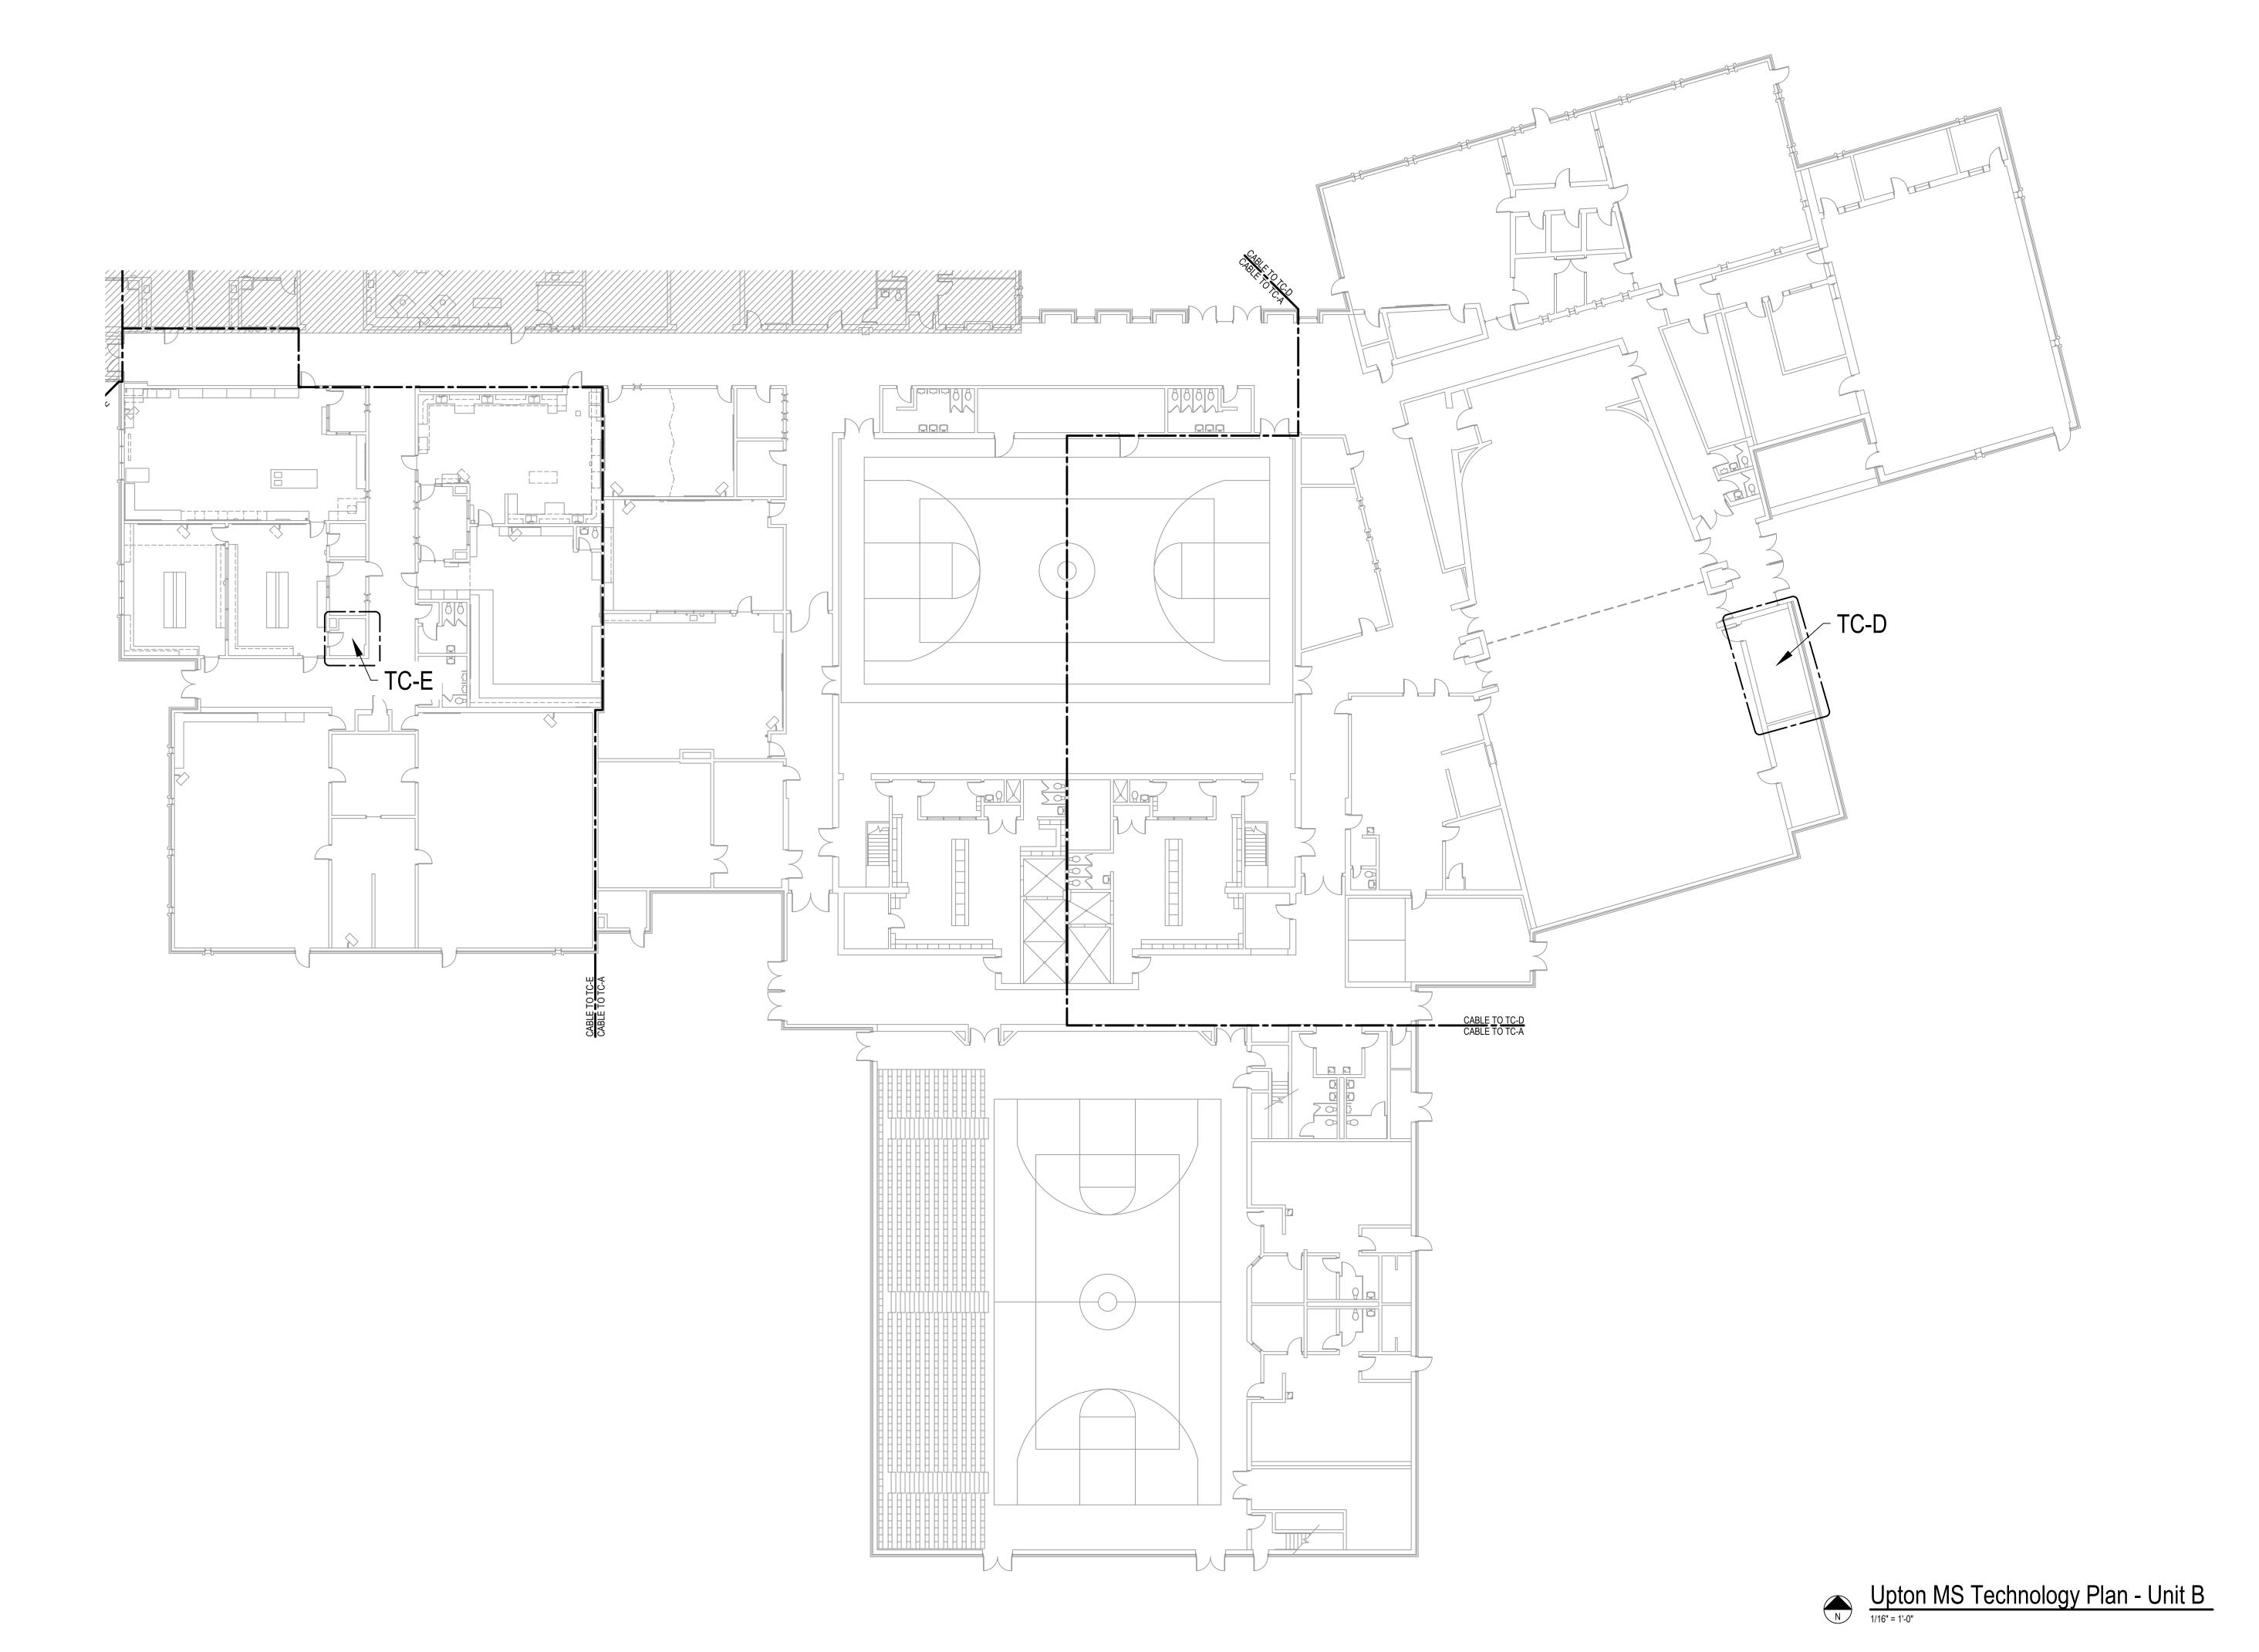
SHEET NO.

1. DEMO ALL ABANDONED CABLES BACK TO THEIR SOURCE.

2. DEMOED EQUIPMENT, WHOLE OR IN PART, SHALL BE PRESENTED TO OWNER FOR FIRST RIGHT OF REFUSAL BEFORE REMOVAL FROM SITE.

3. FLOOR PLANS ARE NOT PROVIDED FOR THE CENTRAL OFFICE, TRANSPORTATION BUILDING, PRESSBOX, AND STADIUM.

6100 NEWPORT ROAD, SUITE #225, PORTAGE, MI 49002· 269-203-2444 · AETECH. DESIGN



Saint Joseph Public Schools Infrastructure Upgrades Saint Joseph, MI


ISSUE / DATE
2023-12-22 BIDS

DRAWN BY
CDB
PROJECT NO.
SJPS2304-0300

SHEET NO.

T104B

DEMO GENERAL NOTES DEMO ALL ABANDONED CABLES BACK TO THEIR SOURCE. DEMOED EQUIPMENT, WHOLE OR IN PART, SHALL BE PRESENTED TO OWNER FOR FIRST RIGHT OF REFUSAL BEFORE REMOVAL FROM SITE. FLOOR PLANS ARE NOT PROVIDED FOR THE CENTRAL OFFICE, TRANSPORTATION BUILDING, PRESSBOX, AND STADIUM. Saint Jose Infrastru Saint Joseph,

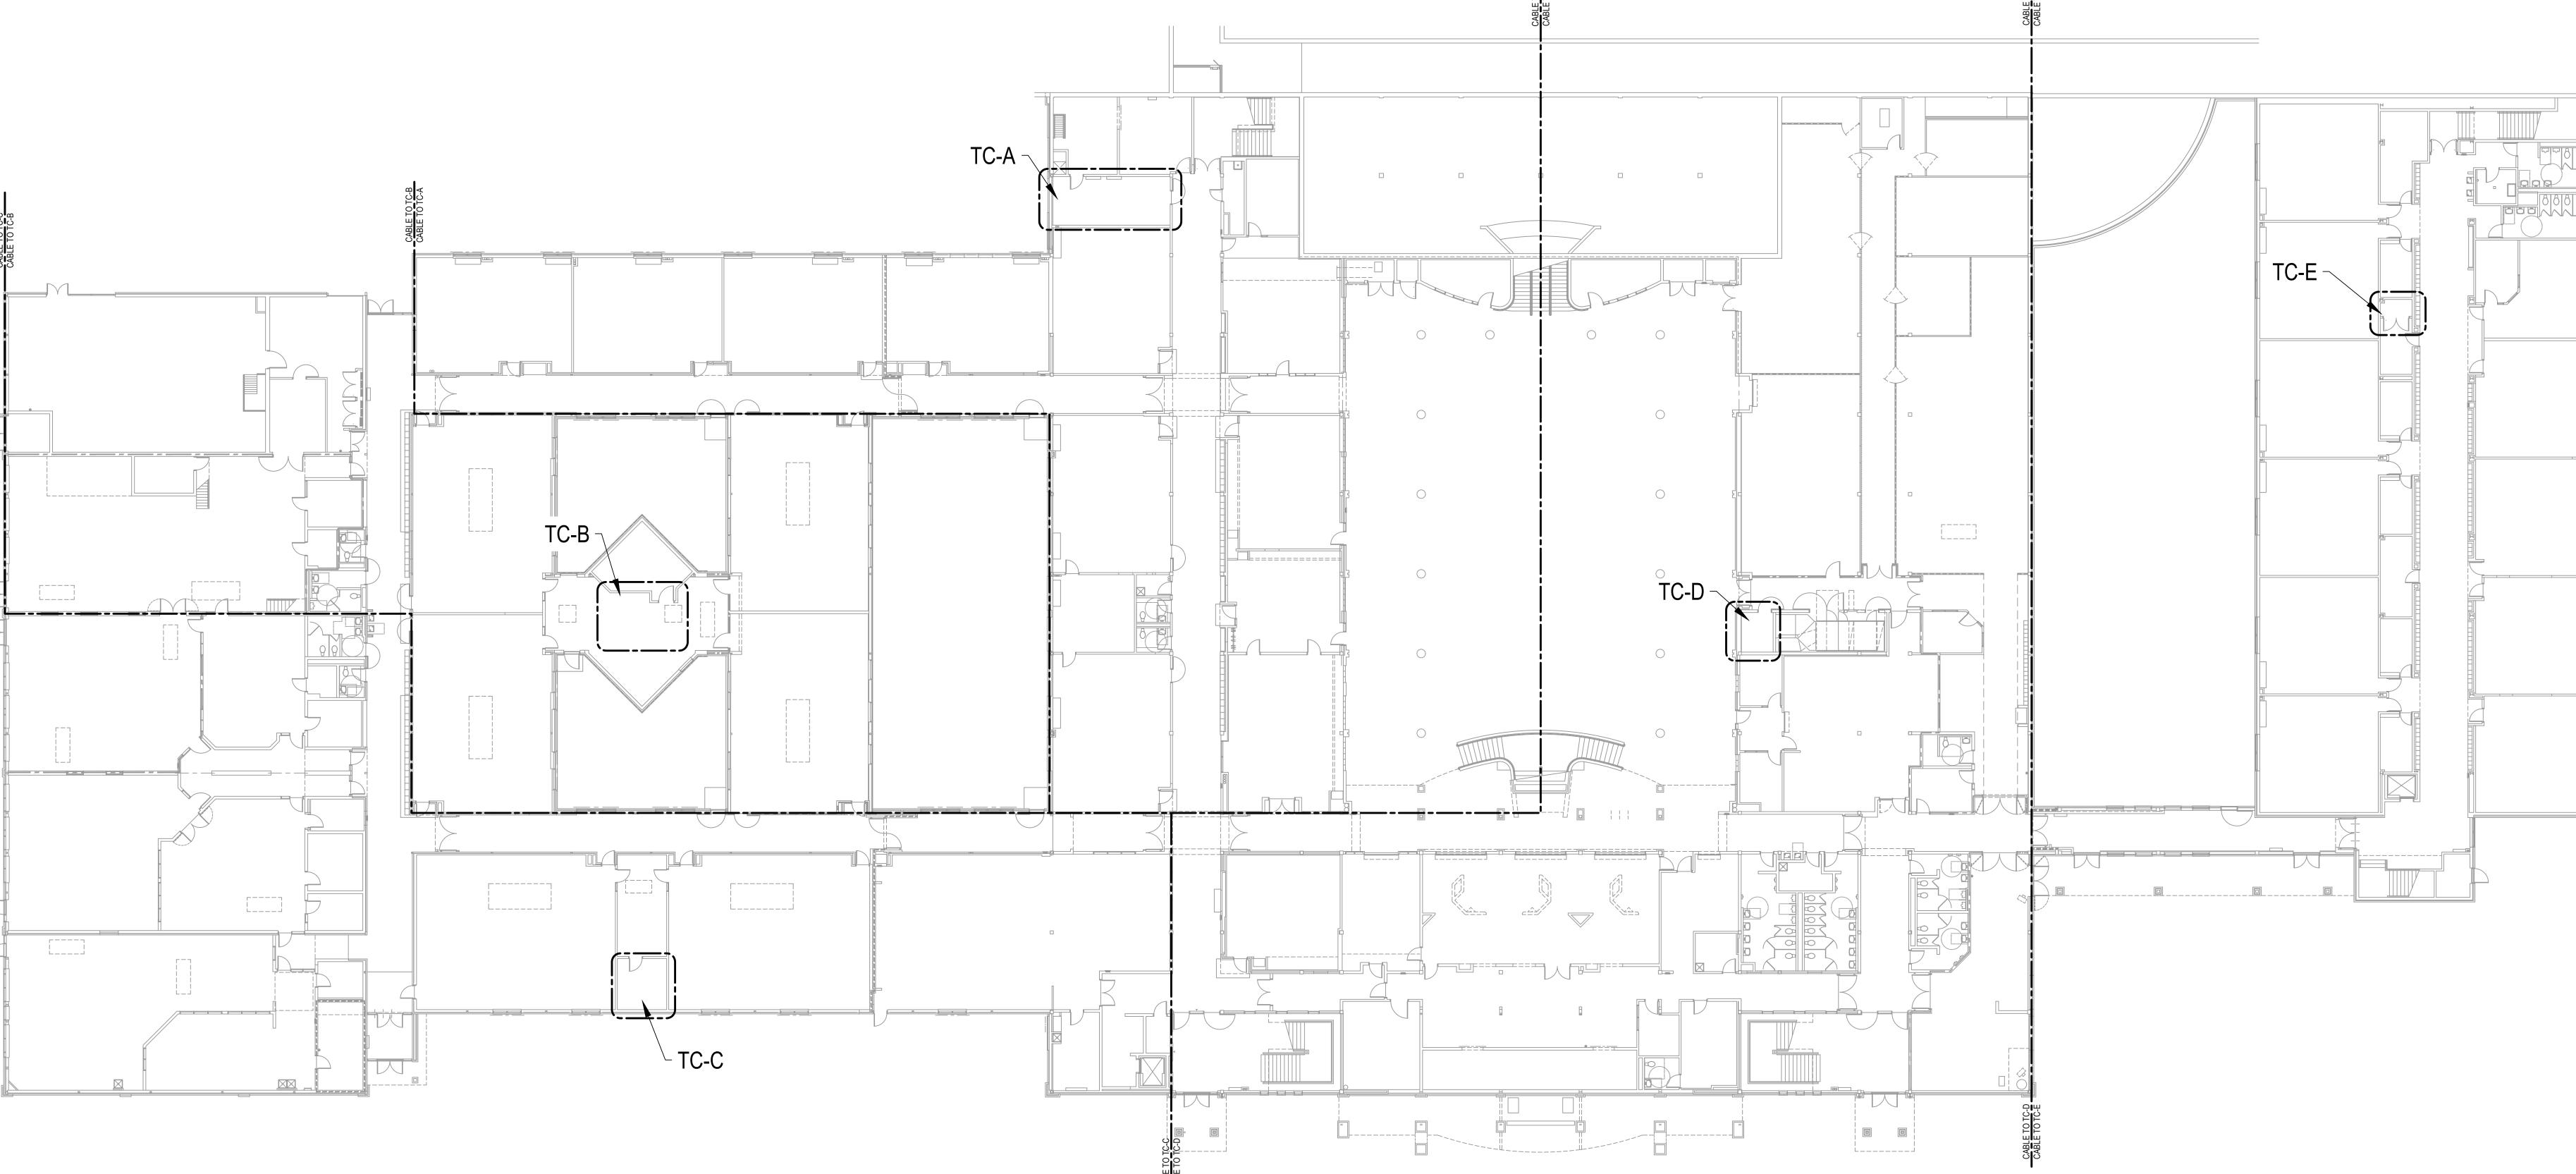


Saint Joseph HS Lower Floor Technology Plan


1/16" = 1'-0"


ISSUE / DATE
2023-12-22 BIDS
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CDB
PROJECT NO.
SJPS2304-0300
SHEET NO.

T105

DEMOED EQUIPMENT, WHOLE OR IN PART, SHALL BE PRESENTED TO OWNER FOR FIRST RIGHT OF REFUSAL BEFORE REMOVAL FROM SITE. FLOOR PLANS ARE NOT PROVIDED FOR THE CENTRAL OFFICE, TRANSPORTATION BUILDING, PRESSBOX, AND STADIUM.

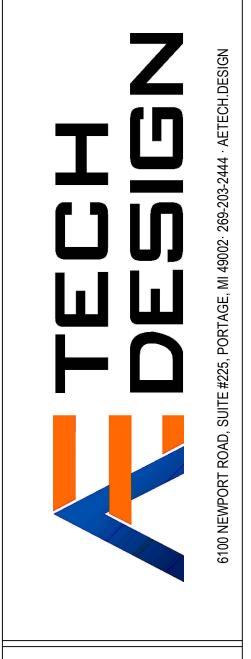

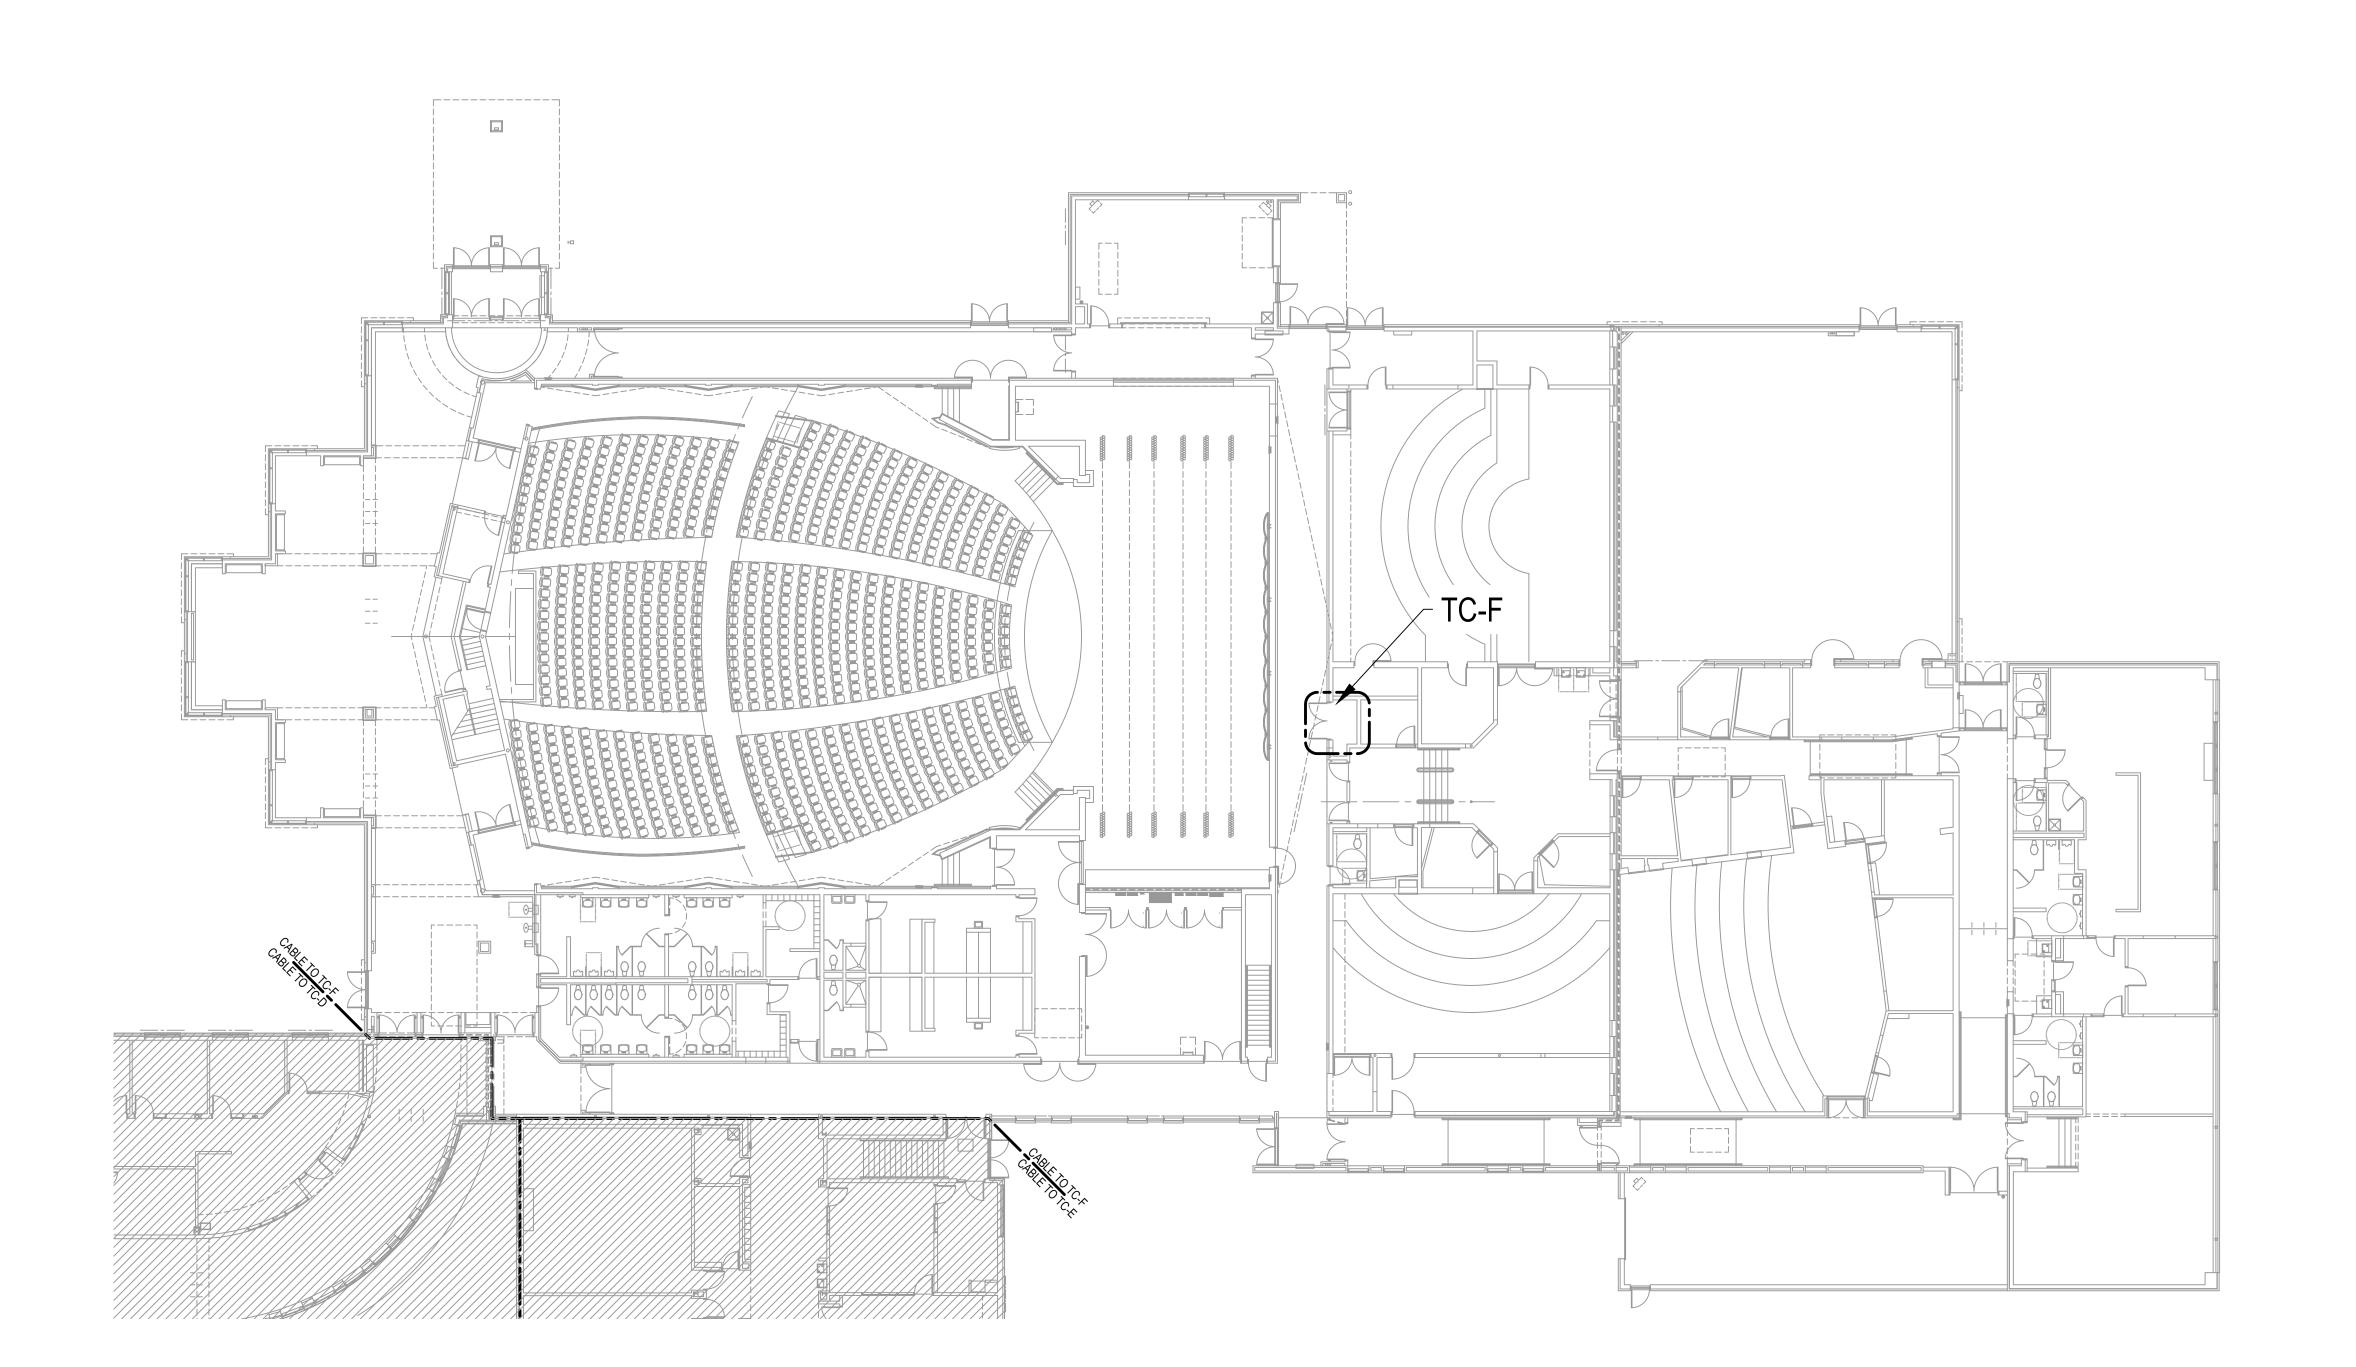

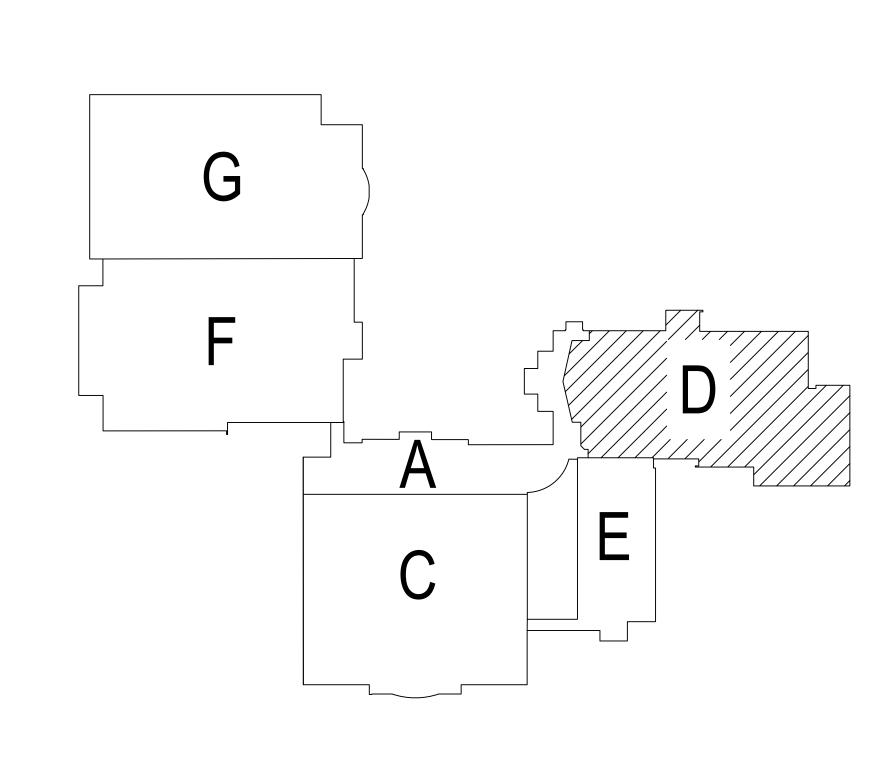


Saint Joseph Public Schools Infrastructure Upgrades Saint Joseph, MI ISSUE / DATE 2023-12-22 BIDS ----------------DRAWN BY CDB PROJECT NO.

SJPS2304-0300 SHEET NO. T106A

DEMO GENERAL NOTES

- 1. DEMO ALL ABANDONED CABLES BACK TO THEIR SOURCE.
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- 3. FLOOR PLANS ARE NOT PROVIDED FOR THE CENTRAL OFFICE, TRANSPORTATION BUILDING, PRESSBOX, AND STADIUM.

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Saint Joseph HS Main Floor Technology Plan - Unit F & G

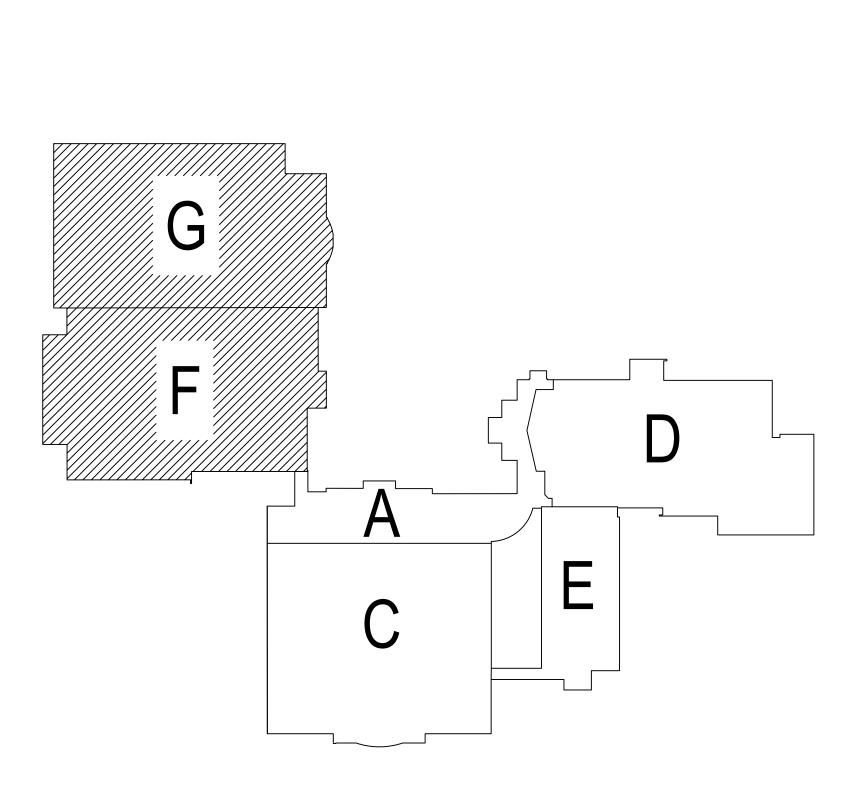Saint Joseph Public Schools
Infrastructure Upgrades
Saint Joseph, MI
Saint Locarb HS Main Floor Tachnolog

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SJPS2304-0300
SHEET NO.


T106B


© 2023 AETD, ALL RIGHTS RESERVED.


2023-12-22 BIDS --------

	DATA LEGEND											
SYMBOL		DECORPTION	LIFIGUE	DATA DRODO	NEW WORK		SURFACE MOUNT		NOTES			
EXISTING	DEMO		NEW	- DESCRIPTION	HEIGHT	DATA DROPS	ROUGH-IN	FACEPLATE	ROUGH-IN	FACEPLATE	ELECTRICAL	LOW VOLTAGE
0	(0)		0	DATA DROP - BLANK	18"AFF	0	1/T302	SEE NOTES	6/T302	SEE NOTES		1
#	<u>(#)</u>		#	DATA DROP - (# INDICATED)	18"AFF	#	1/T302	SEE NOTES	6/T302	SEE NOTES		2
FB #	FB (#)		FB #	DATA DROP - FLOOR BOX	FLOOR	#	SEE ELEC. NOTES	SEE NOTES	N/A	SEE NOTES	7	2
CH #	CH (#)		CH #	DATA DROP - COUNTERHEIGHT	SEE ELEC. NOTES	#	1/T302	SEE NOTES	6/T302	SEE NOTES	8	2
FR #	FR (#)		FR #	DATA DROP - FURNITURE	18"AFF	#	5/T302	11/T302	5/T302	11/T302	9	6
cw #	cw (#)		CW #	DATA DROP - CASEWORK	18"AFF	#	3/T302	SEE NOTES	7/T302	SEE NOTES	10	2
AP	(AP)		AP	WIRELESS ACCESS POINT - CEILING MOUNT	CEILING	1	N/A	SEE NOTES	N/A	SEE NOTES		3, 13
(AP)	(AP)-		(AP)	WIRELESS ACCESS POINT - WALL MOUNT	144"AFF	1	1/T302	8/T302	6/T302	8/T302		3
Р	(P)	1	P	ANALOG PHONE DROP	N/A	1	N/A	N/A	N/A	N/A	11	4
W	(<u>w</u>)	1	W	WALL PHONE	54"AFF	1	1/T302	14/T302	6/T302	14/T302		5
F#	F#]	F#	FACILITIES DROP	SEE ELEC. NOTES	#	N/A	SEE NOTES	N/A	SEE NOTES	12	13

CABLING SUPPORT LEGEND									
SYMBOL	DESCRIPTION	NOTES							
STIVIBUL	DESCRIPTION	ELECTRICAL	LOW VOLTAGE						
E	1-1/2" EMT SLEEVE W/ BUSHINGS								
IE	1-1/2" EMT SLEEVE W/ BUSHINGS; SEAL ENDS W/ FIRE-PROOF PUTTY								
EO	1-1/2" EMT SLEEVE W/ BUSHINGS (UP)								
E ●	1-1/2" EMT SLEEVE W/ BUSHINGS (DOWN)								
	4" EMT SLEEVE W/ BUSHINGS								
	STI EZ-PATH SERIES 44 OR APPROVED EQUIVALENT								
	4" EMT SLEEVE W/ BUSHINGS (UP)								
	4" EMT SLEEVE W/ BUSHINGS (DOWN)								

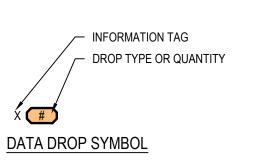

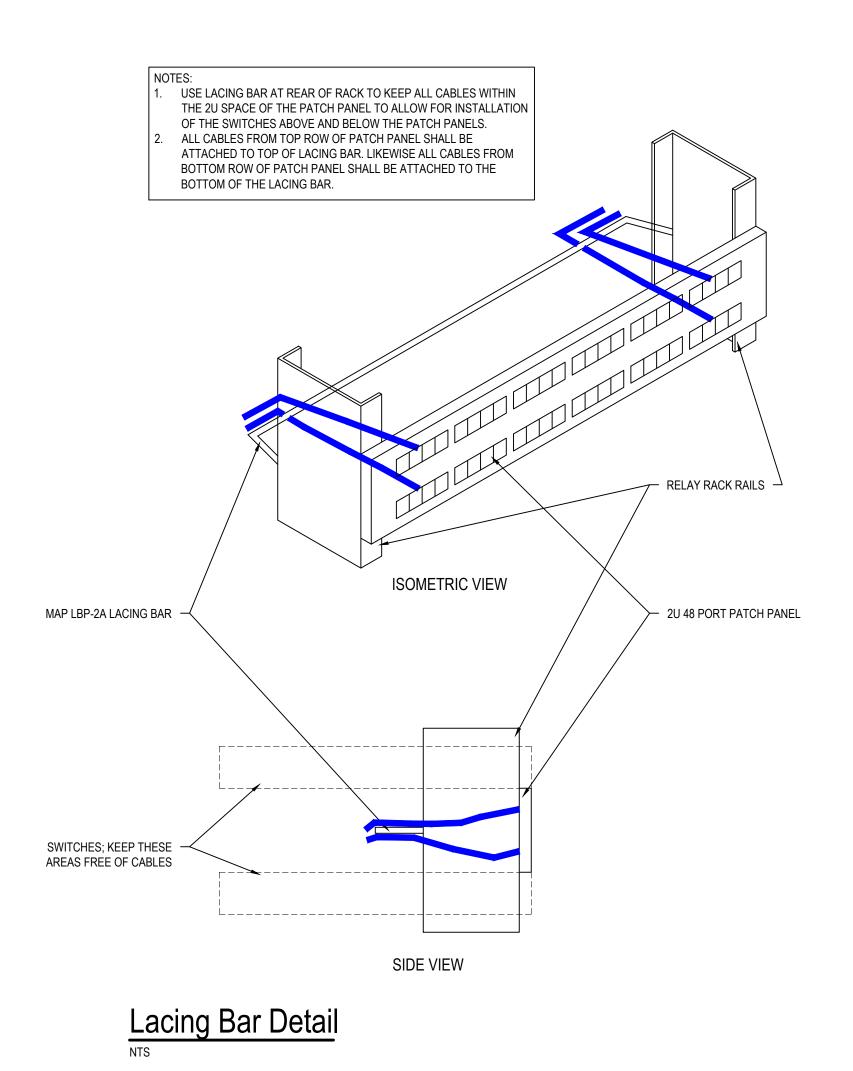

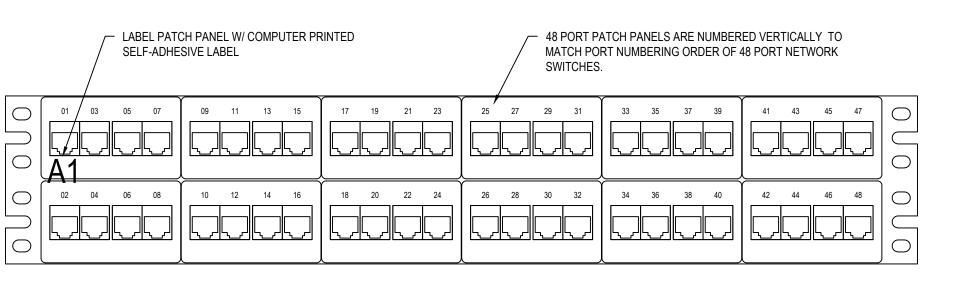

Typical Numbering for 48-Port Patch Panel

DATA LEGEND NOTES

- 1. PROVIDE BLANK FACEPLATE.
- 2. 8/T302, 9/T302, OR 10/T302 DEPENDING ON THE NUMBER OF DROPS.
- 3. PROVIDE 20 FEET OF MAINTENANCE LOOP FOR CABLE.
- 4. TERMINATE ON 110 BLOCK IN TELECOMMUNICATIONS ROOM (TR).
- 5. TERMINATE ON PATCH PANEL IN TECH CLOSET. 6. ROUTE CABLES THROUGH FURNITURE TO FURNITURE FACEPLATE.
- 7. 3/T302 OR 4/T302 AS NEEDED.
- 8. MATCH ELEC. ROUGH-IN HEIGHT, TYPICALLY 8" ABOVE COUNTERTOP.
- 9. FACTORY CUT ROUGH-IN PROVIDED IN MODULAR FURNITURE.
- 10. PROVIDE ROUGH-IN IN FIXED CASEWORK.
- 11. COORDINATE LOCATION W/ EQUIPMENT SERVED.
- 12. COORDINATE FINAL LOCATION W/ BUILDING AUTOMATION SYSTEM CONTRACTOR.
- 13. USE 12/T302 OR 13/T302 DEPENDING ON THE NUMBER OF DROPS.


STRUCTURED CABLING NOTES

- PREVENT POSSIBLE CONFUSION WITH THE NUMBERS ZERO AND ONE.
- ALL ANALOG PHONE DROPS ARE TO BE TERMINATED IN TECH CLOSETS ON 110 PUNCH-DOWN BLOCKS MOUNTED ON BACKBOARD.





FOR ALL ALPHABETIC IDENTIFIERS THE LETTERS "O" AND "I" ARE NOT USED, TO

Structured Cabling General Information Sail Infl Sain ISSUE / DATE 2023-12-22 BIDS ----------------DRAWN BY CDB PROJECT NO. SJPS2304-0300 SHEET NO.

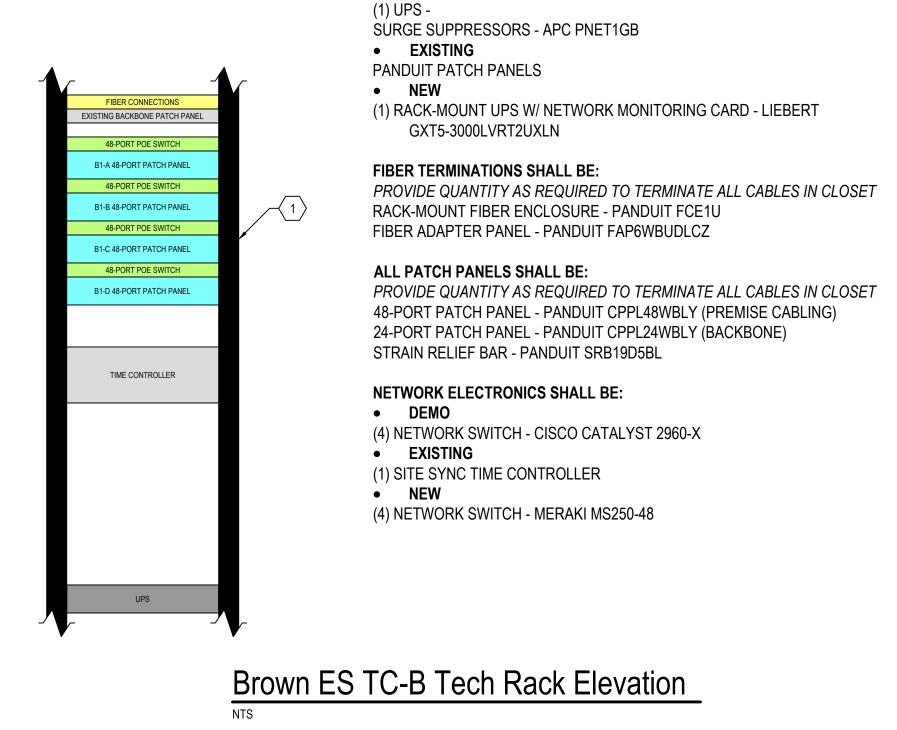

DEMO

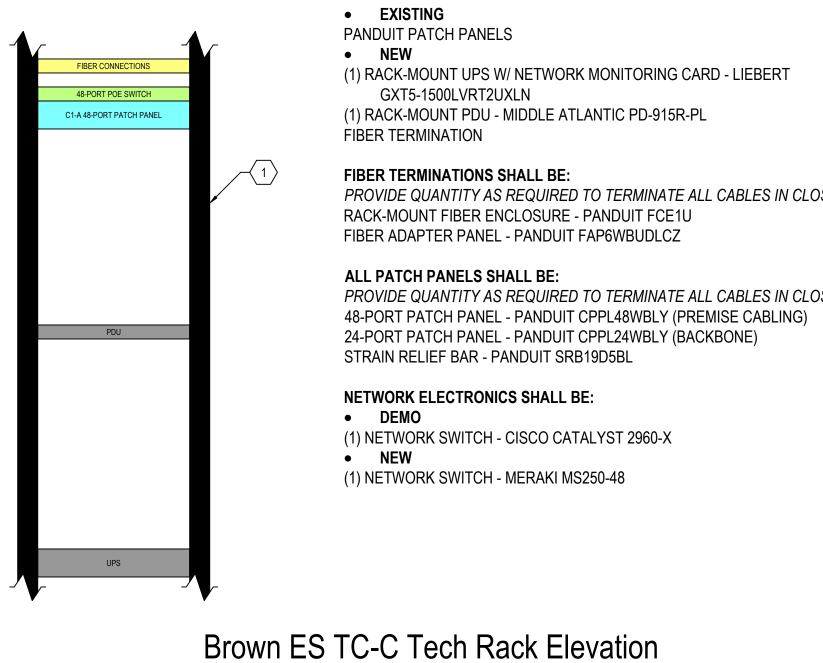


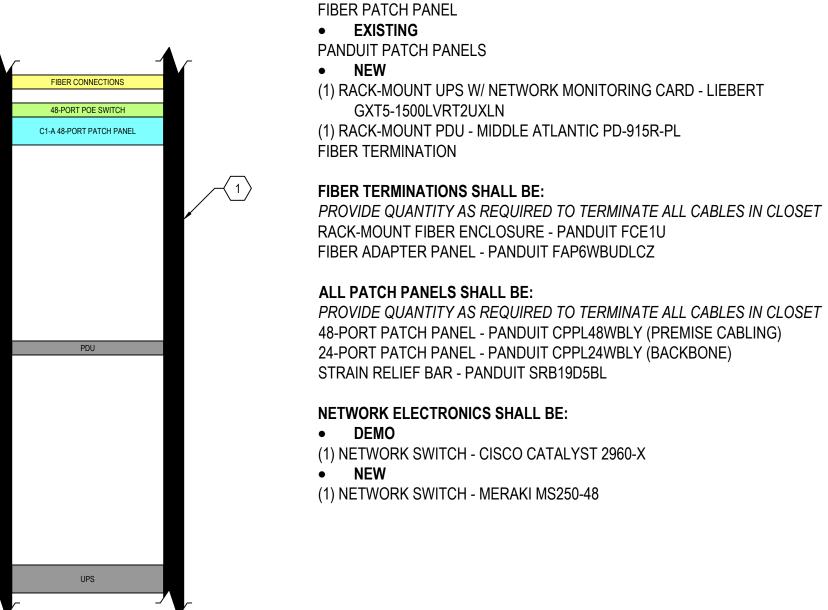

RACK EQUIPMENT SHALL BE:

(1) UPS - LIEBERT GXT3 WITH ADDITIONAL BATTERY PACK

DEMO

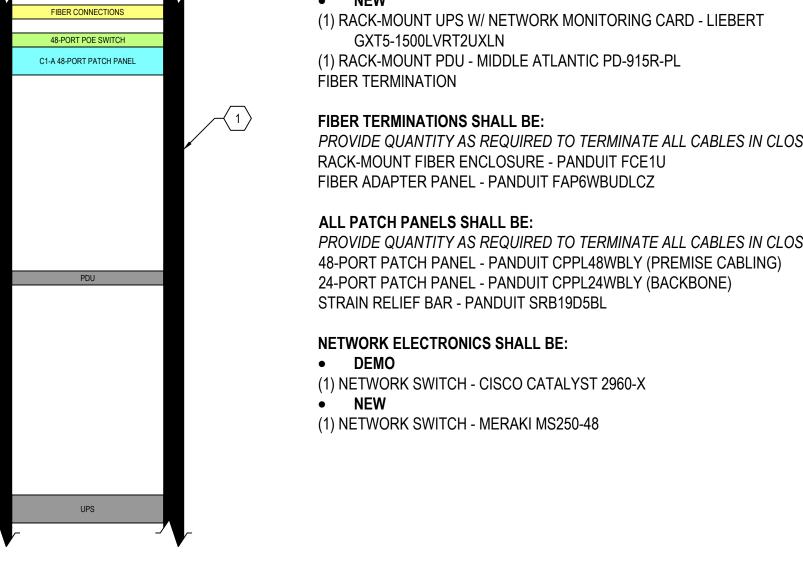

RACK EQUIPMENT SHALL BE:

DEMO

EXISTING

NEW

DEMO

EXISTING

EXISTING BACKBONE PATCH PANEL

48-PORT POE SWITCH

A1-A 48-PORT PATCH PANE

48-PORT POE SWITCH

A1-C 48-PORT PATCH PANEL

48-PORT POE SWITCH

VERTICAL PDU

UPS - LIEBERT GXT3

LEVITON PATCH PANELS

PANDUIT PATCH PANELS

GXT5-3000LVRT2UXLN

FIBER TERMINATIONS SHALL BE:

ALL PATCH PANELS SHALL BE:

RACK-MOUNT FIBER ENCLOSURE - PANDUIT FCE1U

FIBER ADAPTER PANEL - PANDUIT FAP6WBUDLCZ

STRAIN RELIEF BAR - PANDUIT SRB19D5BL

(3) NETWORK SWITCH - MERAKI MS250-48

NETWORK ELECTRONICS SHALL BE:

(1) SITE SYNC TIME CONTROLLER

(1) ROUTER - CISCO 2901


(1) RACK-MOUNT UPS W/ NETWORK MONITORING CARD - LIEBERT

PROVIDE QUANTITY AS REQUIRED TO TERMINATE ALL CABLES IN CLOSET

PROVIDE QUANTITY AS REQUIRED TO TERMINATE ALL CABLES IN CLOSET

48-PORT PATCH PANEL - PANDUIT CPPL48WBLY (PREMISE CABLING)

24-PORT PATCH PANEL - PANDUIT CPPL24WBLY (BACKBONE)

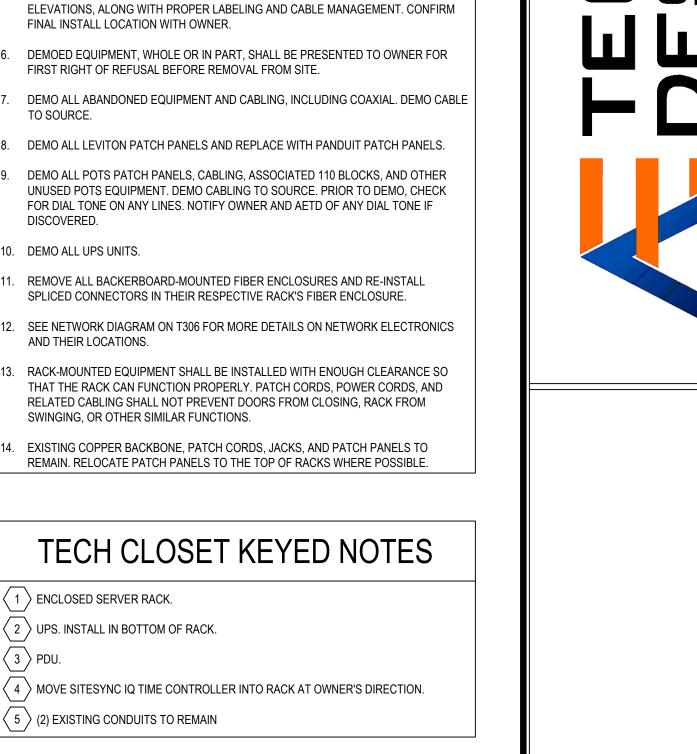

TECH CLOSET GENERAL NOTES

GENERAL BUILDING HVAC SHALL NOT BE INSTALLED IN ANY TECHNOLOGY CLOSET. ACTIVE COOLING IS REQUIRED, DEDICATED LOCAL SYSTEMS SHOULD BE INSTALLED

EQUIPMENT MOUNTED ON BACKERBOARD SHALL MAINTAIN PROPER CLEARANCES

RACK SIZES SHOWN ARE TYPICAL AND MAY NOT MATCH EXISTING RACK SIZES.

FOR OPERATION AND BE COORDINATED WITH OTHER DISCIPLINES PRIOR TO INSTALL

ACTUAL EQUIPMENT LAYOUT IN RACKS SHALL FOLLOW EQUIPMENT ORDER SHOWN IN

ALL OUTLETS IN THE TECHNOLOGY CLOSETS SHOULD BE ON UPS-BACKED,

TECHNOLOGY CLOSETS SHALL BE NON-SPRINKLER SPACES.

IN EACH TECH CLOSET.

DEMO ALL UPS UNITS.

AND THEIR LOCATIONS.

1 ENCLOSED SERVER RACK.

(2) UPS. INSTALL IN BOTTOM OF RACK.

√ 5
√ (2) EXISTING CONDUITS TO REMAIN


SWINGING, OR OTHER SIMILAR FUNCTIONS.

GENERATOR POWERED CIRCUITS.

IF THERE IS A CONFLICT OF PLACEMENT.

FINAL INSTALL LOCATION WITH OWNER.

FIRST RIGHT OF REFUSAL BEFORE REMOVAL FROM SITE.

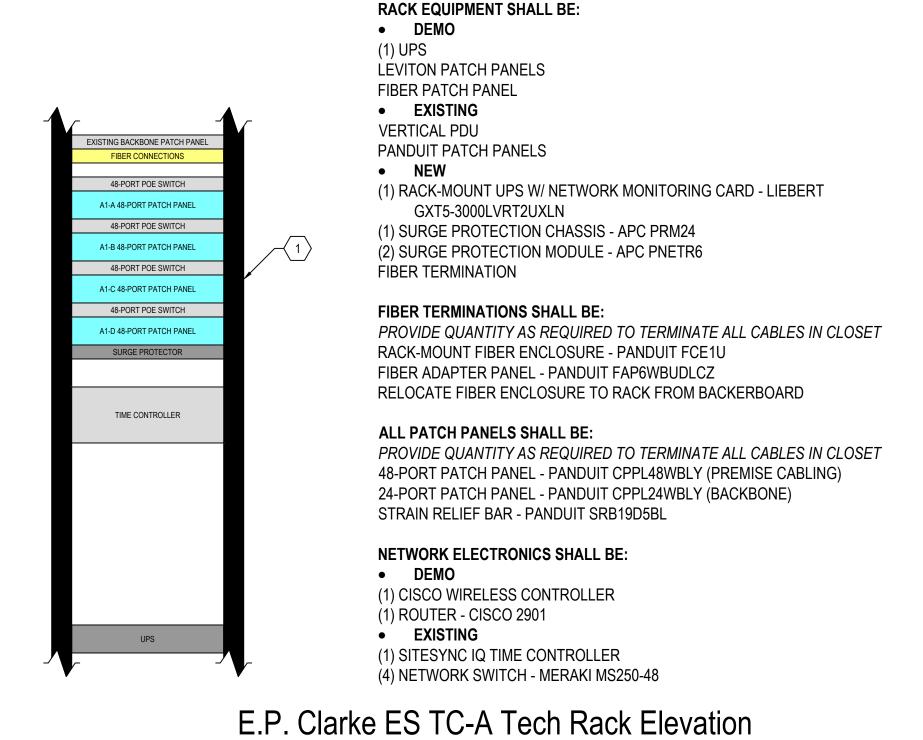

RACK EQUIPMENT SHALL BE:

PANDUIT PATCH PANELS

GXT5-3000LVRT2UXLN

FIBER TERMINATIONS SHALL BE:

ALL PATCH PANELS SHALL BE:

UPS - LIEBERT GXT3 WITH ADDITIONAL BATTERY PACK

RACK-MOUNT FIBER ENCLOSURE - PANDUIT FCE1U

FIBER ADAPTER PANEL - PANDUIT FAP6WBUDLCZ

STRAIN RELIEF BAR - PANDUIT SRB19D5BL

(5) NETWORK SWITCH - MERAKI MS250-48

NETWORK ELECTRONICS SHALL BE:

(1) SITE SYNC TIME CONTROLLER

(1) RACK-MOUNT UPS W/ NETWORK MONITORING CARD - LIEBERT

PROVIDE QUANTITY AS REQUIRED TO TERMINATE ALL CABLES IN CLOSET

PROVIDE QUANTITY AS REQUIRED TO TERMINATE ALL CABLES IN CLOSET

48-PORT PATCH PANEL - PANDUIT CPPL48WBLY (PREMISE CABLING)

24-PORT PATCH PANEL - PANDUIT CPPL24WBLY (BACKBONE)

DEMO

EXISTING BACKBONE PATCH PANEL

48-PORT POE SWITCH

48-PORT POE SWITCH

48-PORT POE SWITCH

B1-C 48-PORT PATCH PANE

48-PORT POE SWITCH

B1-D 48-PORT PATCH PANEL

48-PORT POE SWITC

B1-E 48-PORT PATCH PANEL

TIME CONTROLLER

PDU


UPS

B1-A 48-PORT PATCH PANE

B1-B 48-PORT PATCH PAN

EXISTING


EXISTING

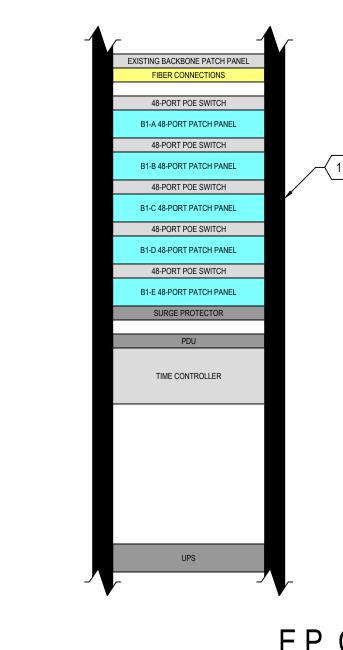

 EXISTING NEW (1) RACK-MOUNT UPS W/ NETWORK MONITORING CARD - LIEBERT GXT5-3000LVRT2UXLN (1) RACK-MOUNT PDU - MIDDLE ATLANTIC PD-915R-PL (1) SURGE PROTECTION CHASSIS - APC PRM24 (4) SURGE PROTECTION MODULE - APC PNETR6 FIBER TERMINATIONS SHALL BE: RACK-MOUNT FIBER ENCLOSURE - PANDUIT FCE1U FIBER ADAPTER PANEL - PANDUIT FAP6WBUDLCZ **ALL PATCH PANELS SHALL BE:** 48-PORT PATCH PANEL - PANDUIT CPPL48WBLY (PREMISE CABLING) 24-PORT PATCH PANEL - PANDUIT CPPL24WBLY (BACKBONE) STRAIN RELIEF BAR - PANDUIT SRB19D5BL **NETWORK ELECTRONICS SHALL BE:** EXISTING (5) NETWORK SWITCH - MERAKI MS250-48 (1) SITESYNC IQ TIME CONTROLLER

TIME CONTROLLER UPS


Lincoln ES TC-A Tech Rack Elevation

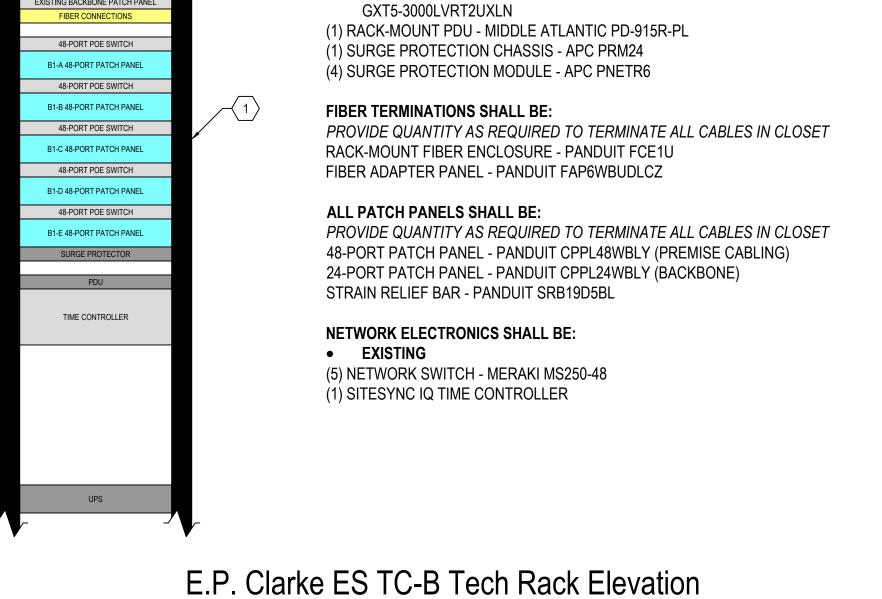


RACK EQUIPMENT SHALL BE:

DEMO

(1) UPS -

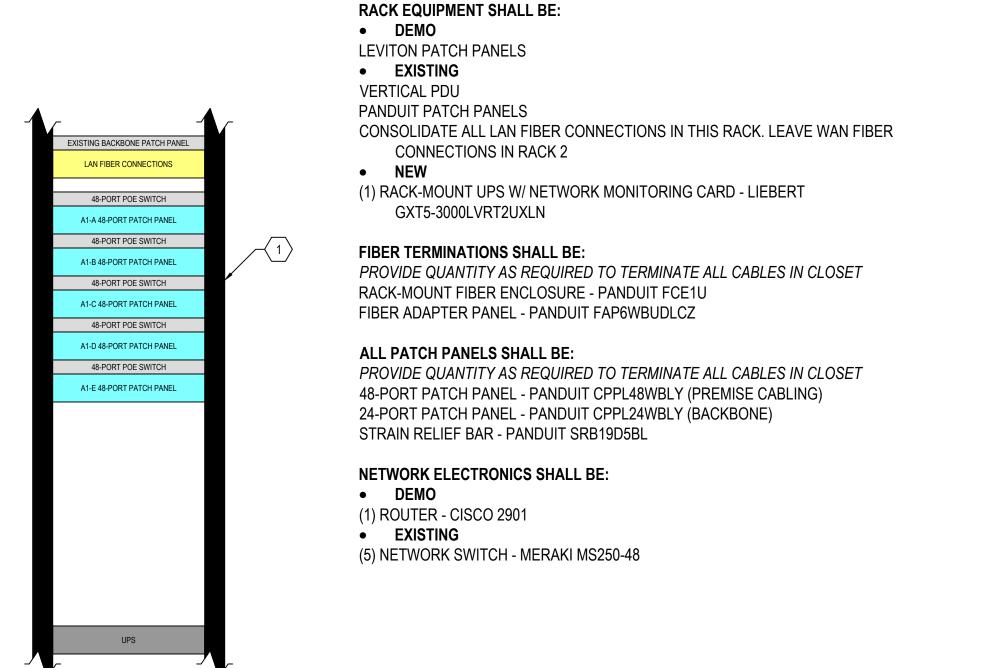

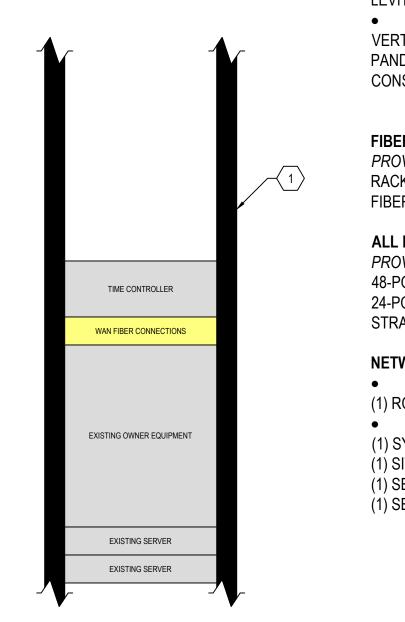

(2) UPS - LIEBERT GXT3 WITH ADDITIONAL BATTERY PACK LEVITON PATCH PANELS EXISTING VERTICAL PDU PANDUIT PATCH PANELS CONSOLIDATE ALL LAN FIBER CONNECTIONS IN RACK 1. LEAVE WAN FIBER CONNECTIONS IN THIS RACK FIBER TERMINATIONS SHALL BE: PROVIDE QUANTITY AS REQUIRED TO TERMINATE ALL CABLES IN CLOSET RACK-MOUNT FIBER ENCLOSURE - PANDUIT FCE1U FIBER ADAPTER PANEL - PANDUIT FAP6WBUDLCZ **ALL PATCH PANELS SHALL BE:** PROVIDE QUANTITY AS REQUIRED TO TERMINATE ALL CABLES IN CLOSET 48-PORT PATCH PANEL - PANDUIT CPPL48WBLY (PREMISE CABLING) 24-PORT PATCH PANEL - PANDUIT CPPL24WBLY (BACKBONE) STRAIN RELIEF BAR - PANDUIT SRB19D5BL **NETWORK ELECTRONICS SHALL BE:** DEMO (1) ROUTER - CISCO 2901 EXISTING (1) SYNOLOGY STORAGE DEVICE (1) SITE SYNC TIME CONTROLLER

RACK EQUIPMENT SHALL BE:

DEMO

(1) SERVER - HP PROLIANT DL180 G6 (1) SERVER - HP PROLIANT DL380 G7 Joseph Public Istructure U Sai Inf Sain ISSUE / DATE ------------

SHEET NO.


Upton MS TC-A Tech Rack 1 Elevation Lincoln ES TC-B Tech Rack Elevation

Upton MS TC-A Tech Rack 2 Elevation

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olic Schools Upgrades

2023-12-22 BIDS DRAWN BY CDB PROJECT NO. SJPS2304-0300

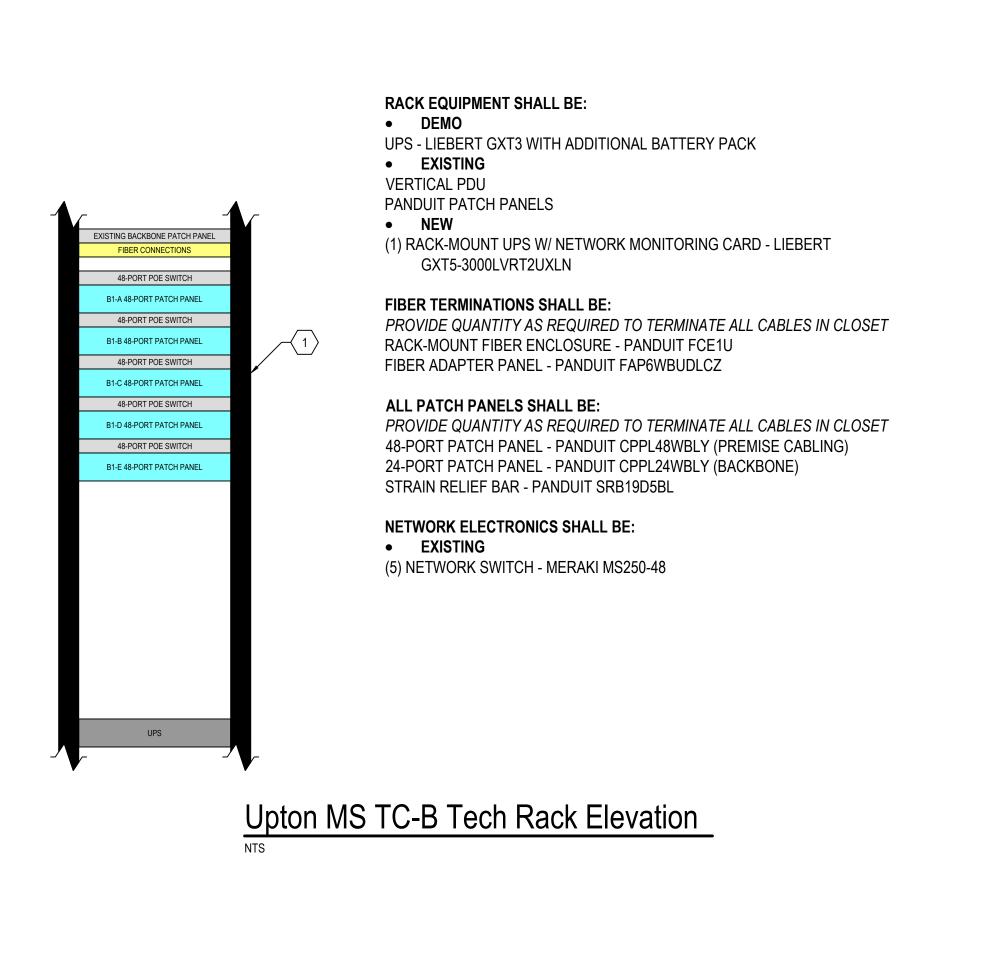

LEVITON PATCH PANELS

PANDUIT PATCH PANELS

GXT5-3000LVRT2UXLN

FIBER TERMINATIONS SHALL BE:

ALL PATCH PANELS SHALL BE:

UPS - LIEBERT GXT3 WITH ADDITIONAL BATTERY PACK

RACK-MOUNT FIBER ENCLOSURE - PANDUIT FCE1U

FIBER ADAPTER PANEL - PANDUIT FAP6WBUDLCZ

STRAIN RELIEF BAR - PANDUIT SRB19D5BL

(4) NETWORK SWITCH - MERAKI MS250-48

NETWORK ELECTRONICS SHALL BE:

(1) RACK-MOUNT UPS W/ NETWORK MONITORING CARD - LIEBERT

PROVIDE QUANTITY AS REQUIRED TO TERMINATE ALL CABLES IN CLOSET

PROVIDE QUANTITY AS REQUIRED TO TERMINATE ALL CABLES IN CLOSET

48-PORT PATCH PANEL - PANDUIT CPPL48WBLY (PREMISE CABLING)

24-PORT PATCH PANEL - PANDUIT CPPL24WBLY (BACKBONE)

DEMO

 EXISTING **VERTICAL PDU**

NEW

EXISTING

Upton MS TC-E Tech Rack Elevation

FIBER CONNECTIONS

48-PORT POE SWITCH

E1-A 48-PORT PATCH PANE 48-PORT POE SWITCH

E1-B 48-PORT PATCH PANE


48-PORT POE SWITCH

E1-C 48-PORT PATCH PANEI


48-PORT POE SWITCH E1-D 48-PORT PATCH PANEI


PDU

UPS

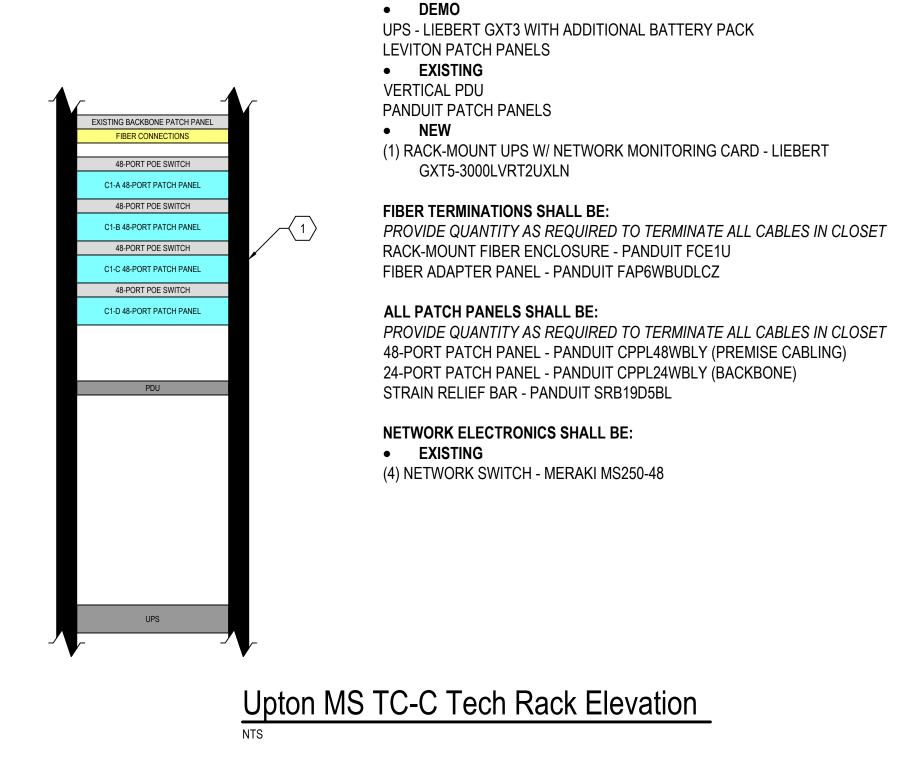

RACK EQUIPMENT SHALL BE:

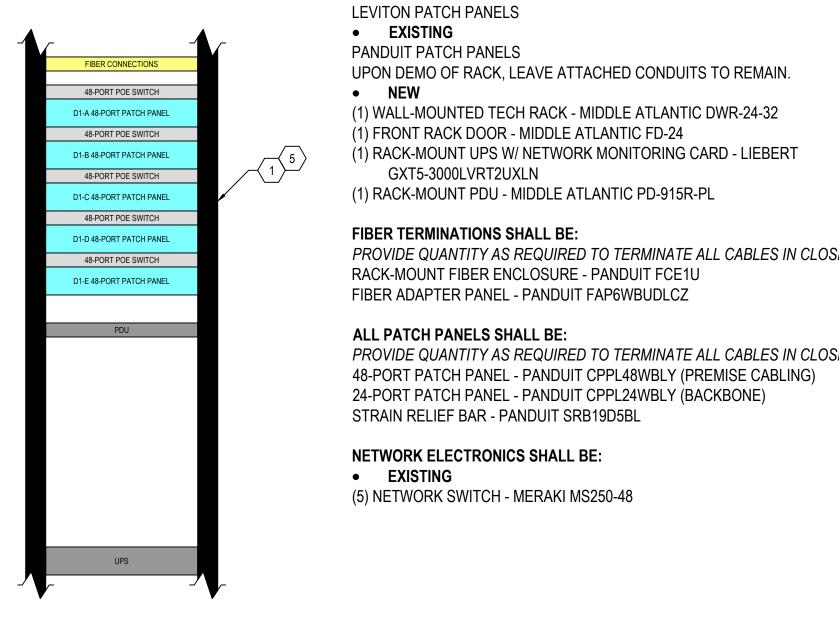

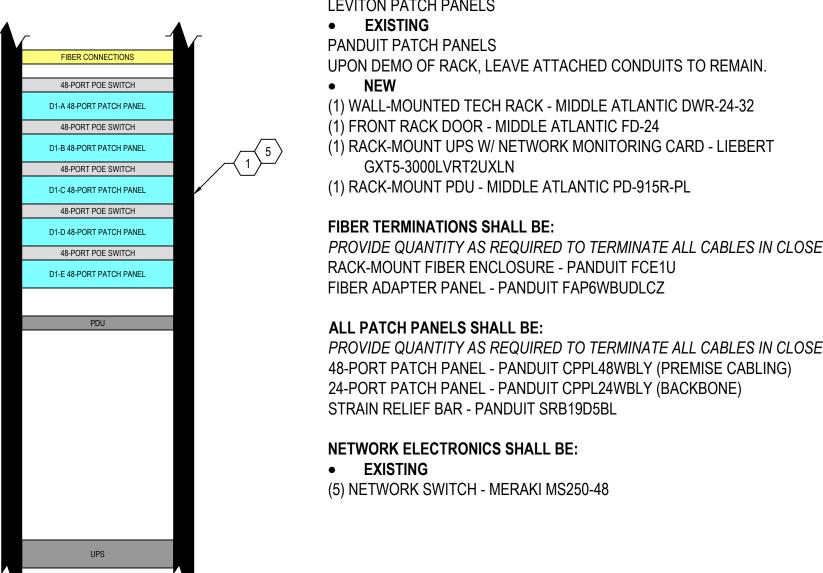



RACK EQUIPMENT SHALL BE:


WALL-MOUNTED TECH RACK


UPS - LIEBERT GXT3 WITH ADDITIONAL BATTERY PACK

DEMO

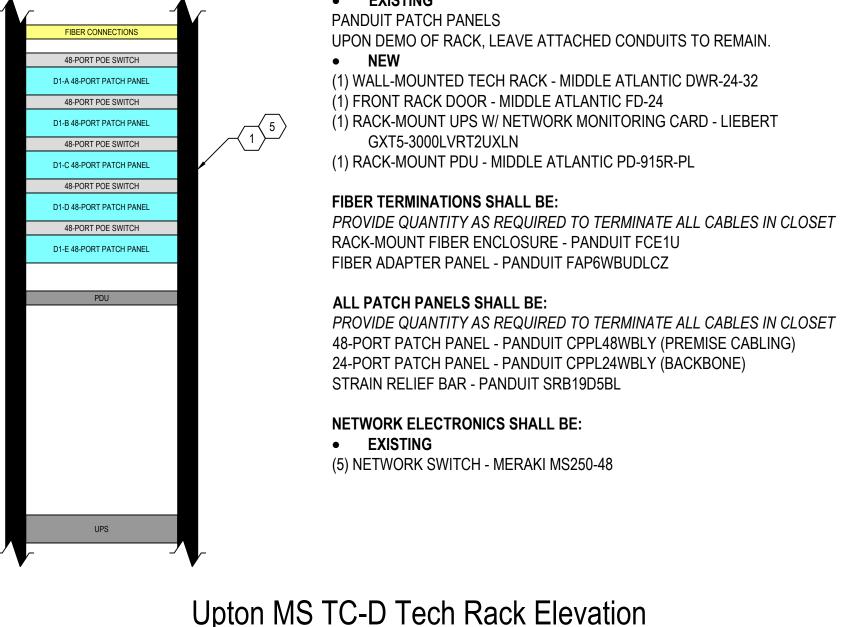

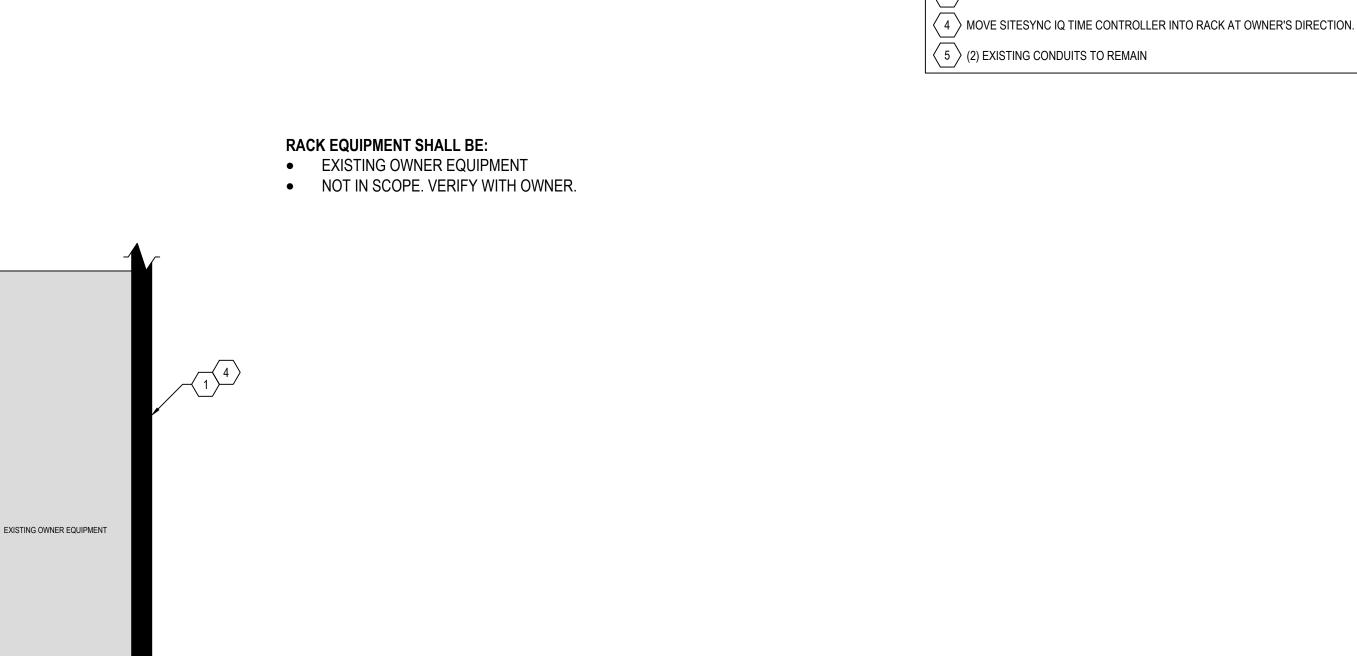

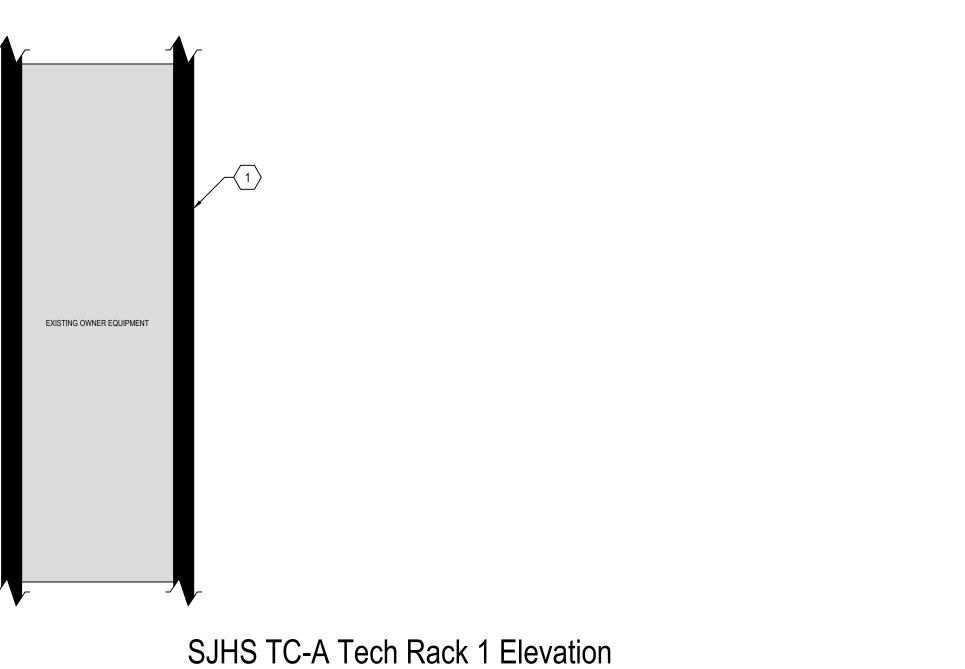


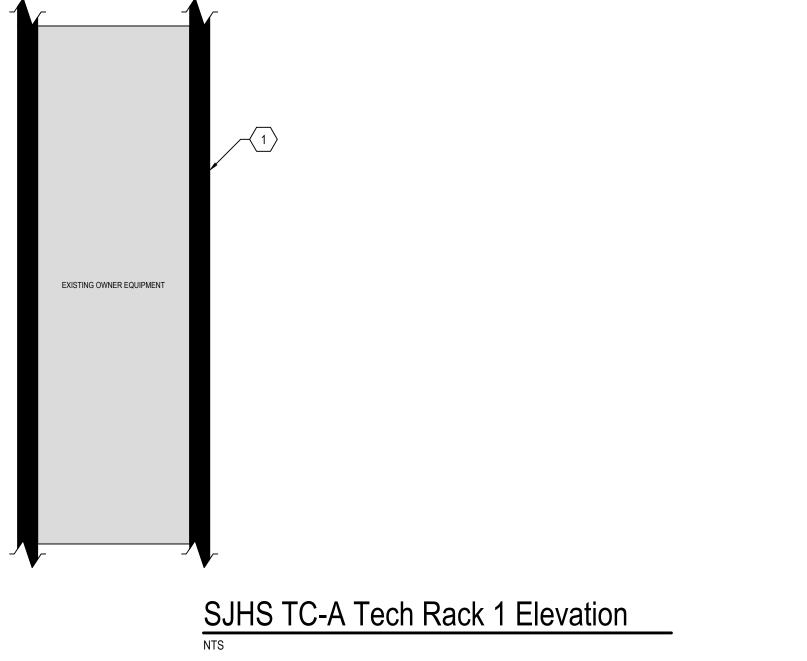


RACK EQUIPMENT SHALL BE:


EXISTING OWNER EQUIPMENT

NOT IN SCOPE. VERIFY WITH OWNER.

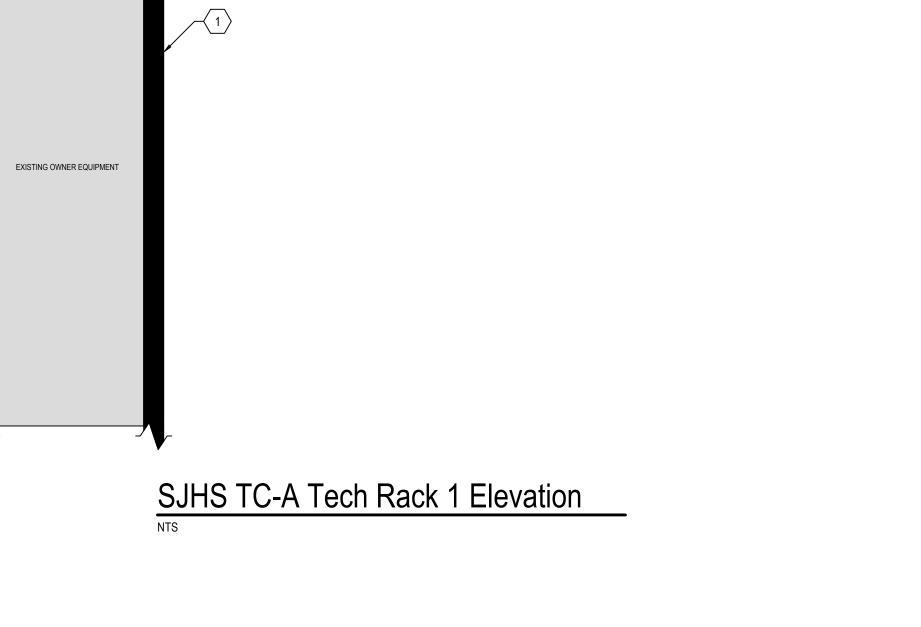

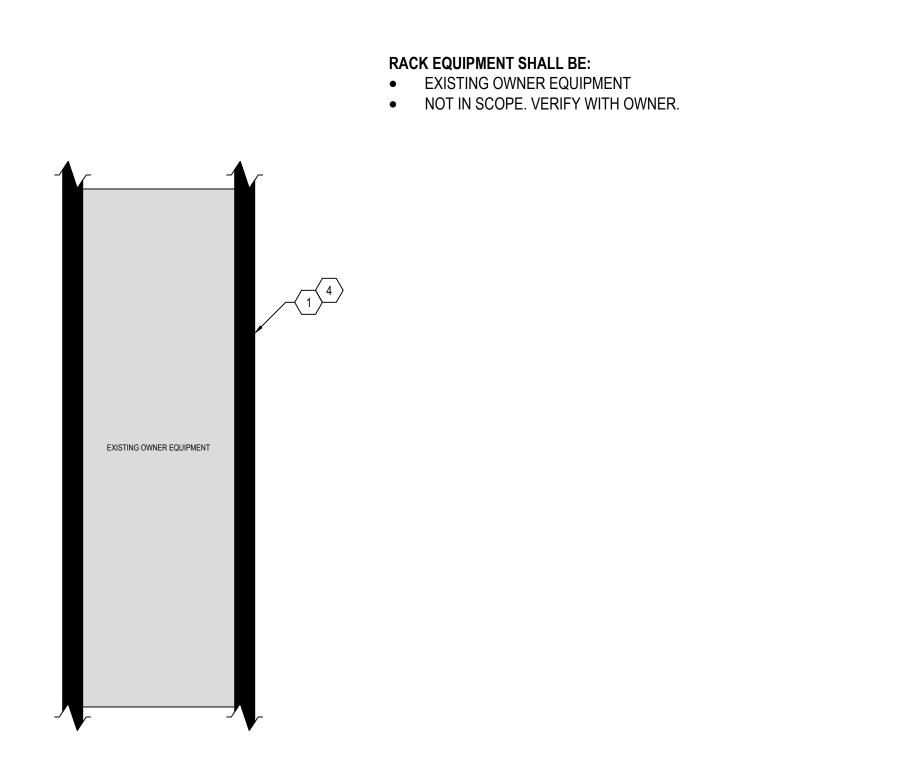


SJHS TC-A Tech Rack 3 Elevation

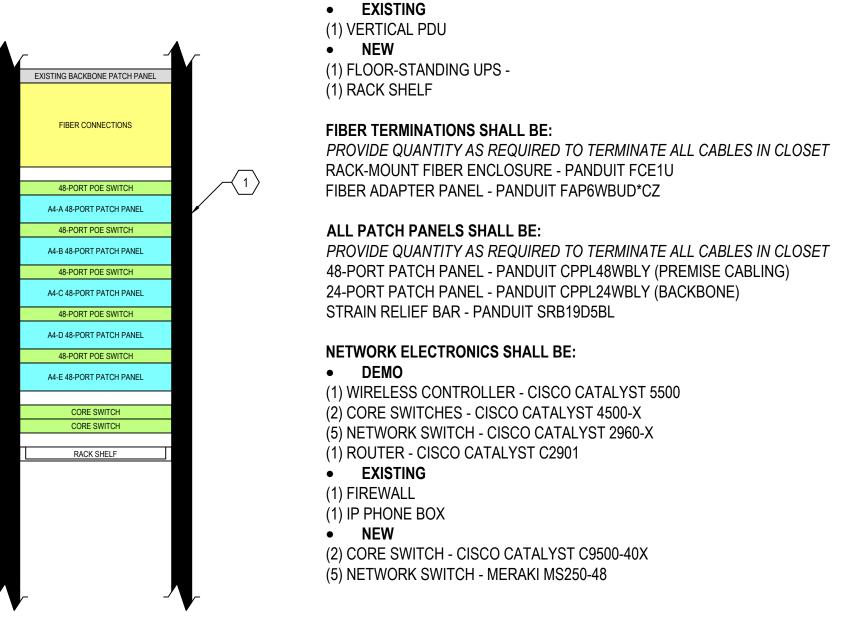


RACK EQUIPMENT SHALL BE:

(1) FLOOR STANDING UPS - LIEBERT NFINITY

DEMO

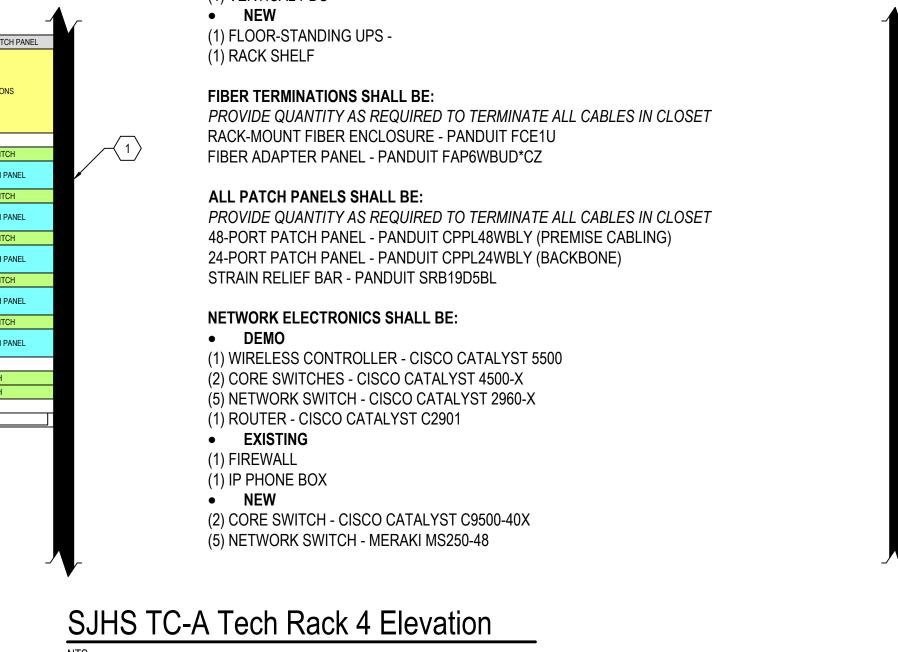

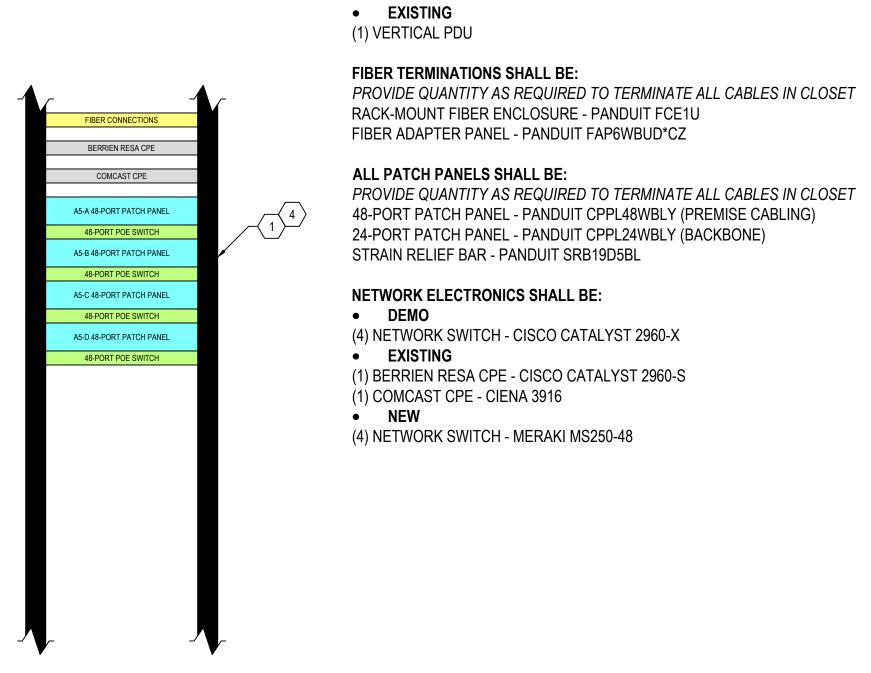

SJHS TC-A Tech Rack 2 Elevation

RACK EQUIPMENT SHALL BE:

SJHS TC-A Tech Rack 5 Elevation

TECH CLOSET GENERAL NOTES

GENERAL BUILDING HVAC SHALL NOT BE INSTALLED IN ANY TECHNOLOGY CLOSET. ACTIVE COOLING IS REQUIRED, DEDICATED LOCAL SYSTEMS SHOULD BE INSTALLED

EQUIPMENT MOUNTED ON BACKERBOARD SHALL MAINTAIN PROPER CLEARANCES

RACK SIZES SHOWN ARE TYPICAL AND MAY NOT MATCH EXISTING RACK SIZES.

FOR OPERATION AND BE COORDINATED WITH OTHER DISCIPLINES PRIOR TO INSTALL

ACTUAL EQUIPMENT LAYOUT IN RACKS SHALL FOLLOW EQUIPMENT ORDER SHOWN IN

ELEVATIONS, ALONG WITH PROPER LABELING AND CABLE MANAGEMENT. CONFIRM

DEMOED EQUIPMENT, WHOLE OR IN PART, SHALL BE PRESENTED TO OWNER FOR

DEMO ALL ABANDONED EQUIPMENT AND CABLING, INCLUDING COAXIAL. DEMO CABLE

DEMO ALL LEVITON PATCH PANELS AND REPLACE WITH PANDUIT PATCH PANELS.

DEMO ALL POTS PATCH PANELS, CABLING, ASSOCIATED 110 BLOCKS, AND OTHER

UNUSED POTS EQUIPMENT. DEMO CABLING TO SOURCE. PRIOR TO DEMO, CHECK

FOR DIAL TONE ON ANY LINES. NOTIFY OWNER AND AETD OF ANY DIAL TONE IF

REMOVE ALL BACKERBOARD-MOUNTED FIBER ENCLOSURES AND RE-INSTALL

SEE NETWORK DIAGRAM ON T306 FOR MORE DETAILS ON NETWORK ELECTRONICS

RACK-MOUNTED EQUIPMENT SHALL BE INSTALLED WITH ENOUGH CLEARANCE SO THAT THE RACK CAN FUNCTION PROPERLY. PATCH CORDS, POWER CORDS, AND

RELATED CABLING SHALL NOT PREVENT DOORS FROM CLOSING, RACK FROM

EXISTING COPPER BACKBONE, PATCH CORDS, JACKS, AND PATCH PANELS TO REMAIN, RELOCATE PATCH PANELS TO THE TOP OF RACKS WHERE POSSIBLE.

TECH CLOSET KEYED NOTES

SPLICED CONNECTORS IN THEIR RESPECTIVE RACK'S FIBER ENCLOSURE.

ALL OUTLETS IN THE TECHNOLOGY CLOSETS SHOULD BE ON UPS-BACKED,

TECHNOLOGY CLOSETS SHALL BE NON-SPRINKLER SPACES.

IN EACH TECH CLOSET.

DEMO ALL UPS UNITS.

AND THEIR LOCATIONS.

1 ENCLOSED SERVER RACK.

 $\left(\begin{array}{c}2\end{array}
ight)$ UPS. INSTALL IN BOTTOM OF RACK.

SWINGING, OR OTHER SIMILAR FUNCTIONS.

GENERATOR POWERED CIRCUITS.


IF THERE IS A CONFLICT OF PLACEMENT.


FINAL INSTALL LOCATION WITH OWNER.

FIRST RIGHT OF REFUSAL BEFORE REMOVAL FROM SITE.

Sai Inf Sain ISSUE / DATE 2023-12-22 BIDS ----------------DRAWN BY CDB

PROJECT NO. SJPS2304-0300 SHEET NO.

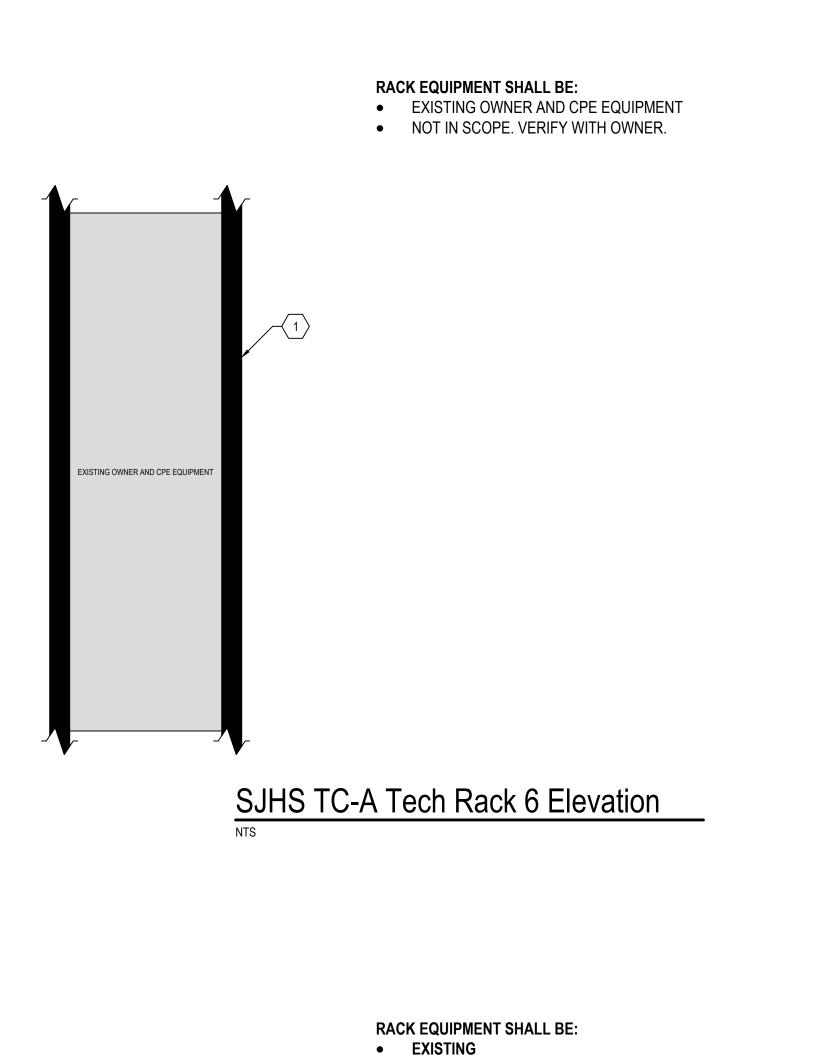

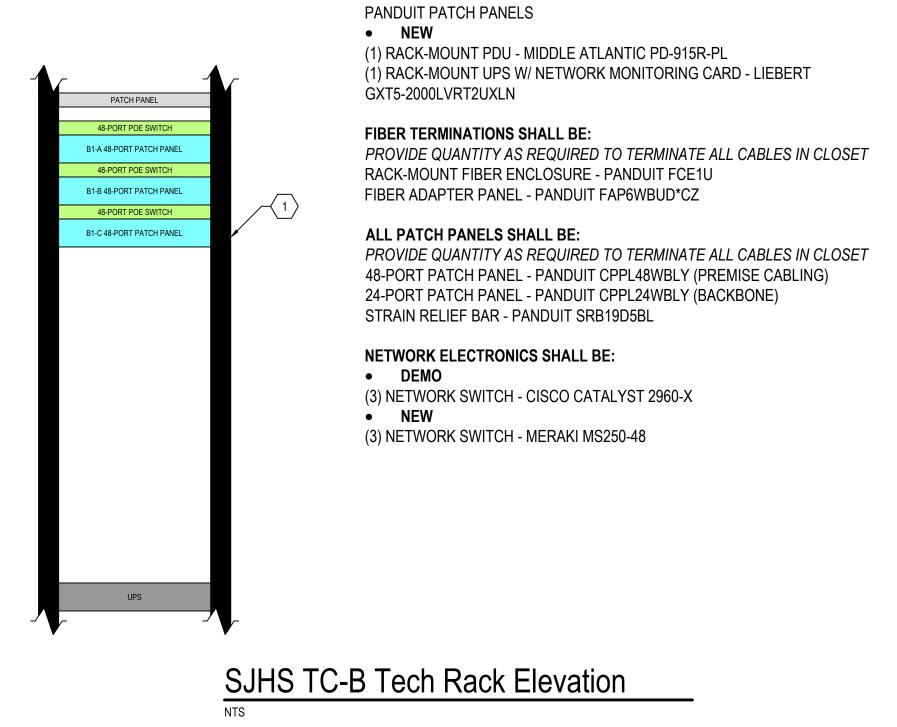

GXT5-3000LVRT2UXLN

(1) RACK-MOUNT PDU - MIDDLE ATLANTIC PD-915R-PL

(1) RACK-MOUNT UPS W/ NETWORK MONITORING CARD - LIEBERT


EXISTING

FIBER CONNECTIONS

PANDUIT PATCH PANELS


RACK EQUIPMENT SHALL BE:

EXISTING

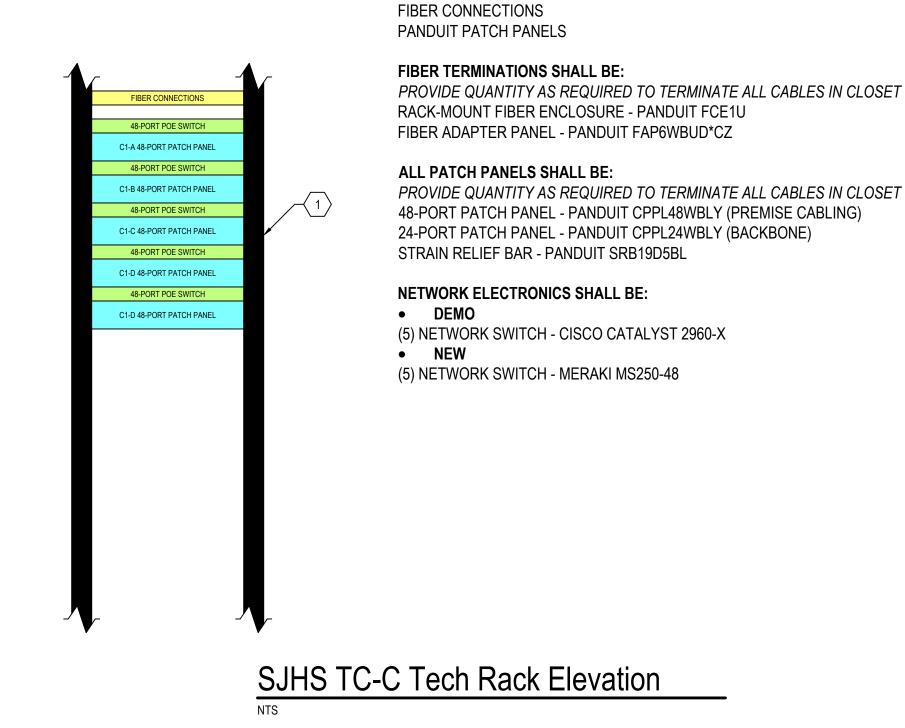

RACK EQUIPMENT SHALL BE:

EXISTING

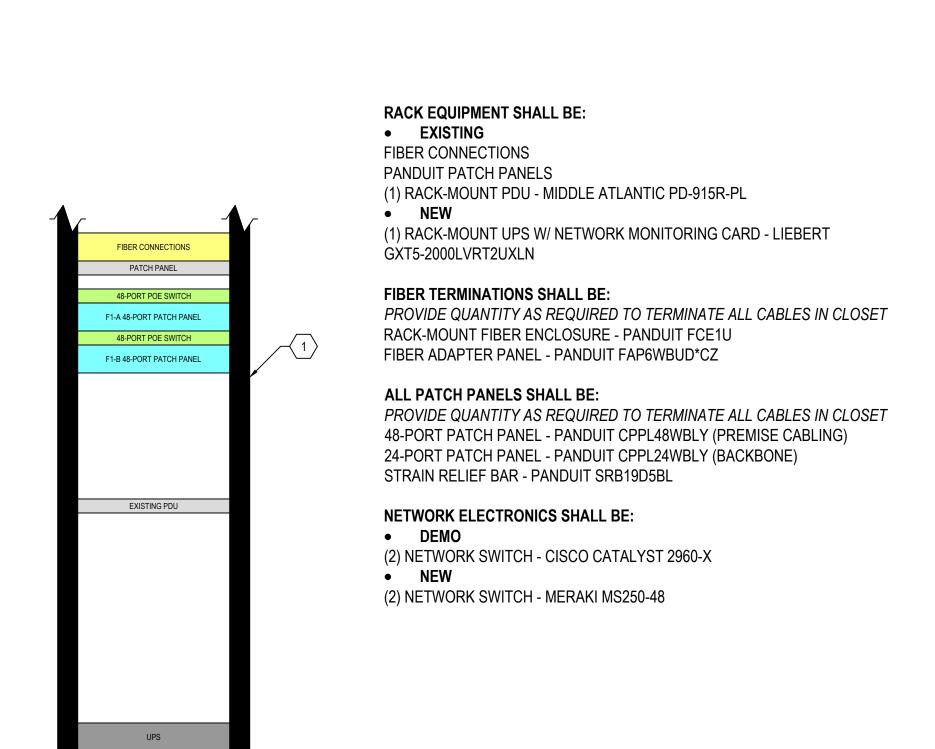


SJHS TC-F Tech Rack Elevation

RACK EQUIPMENT SHALL BE:

LEVITON PATCH PANELS

DEMO

EXISTING

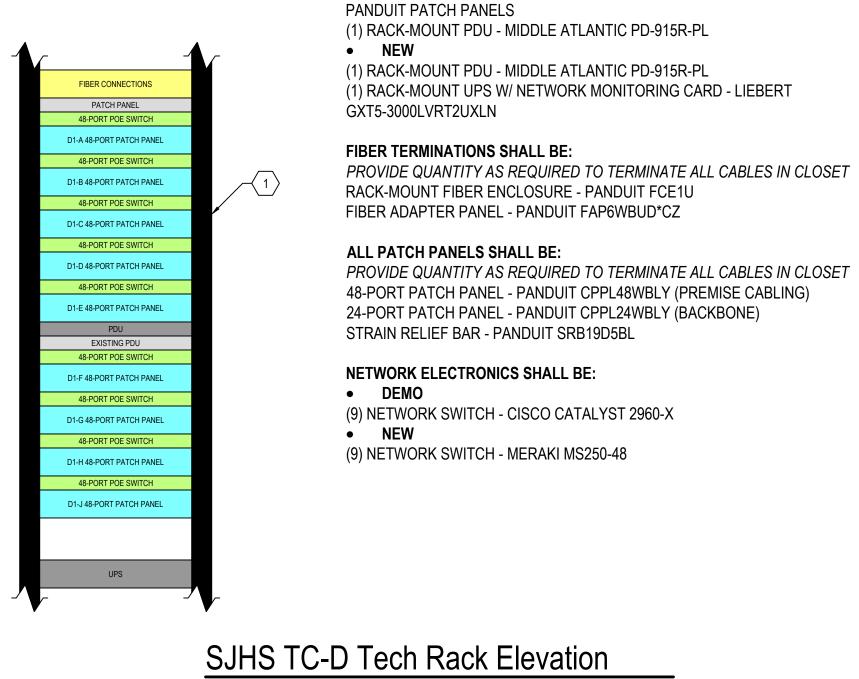



SJHS TC-G Tech Rack Elevation


FIBER CONNECTIONS




FIBER CONNECTIONS

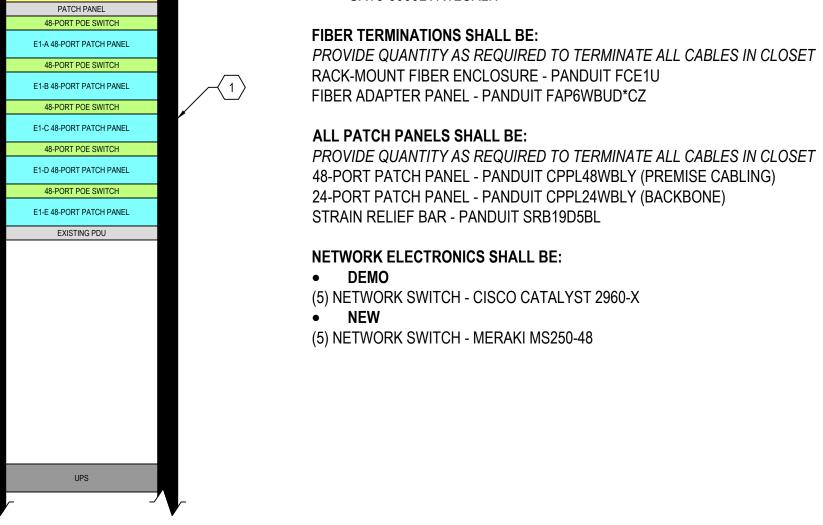

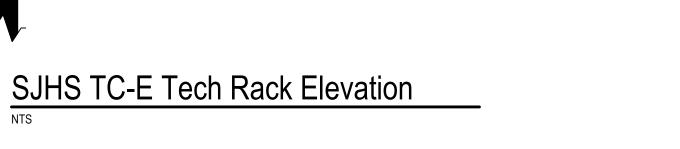

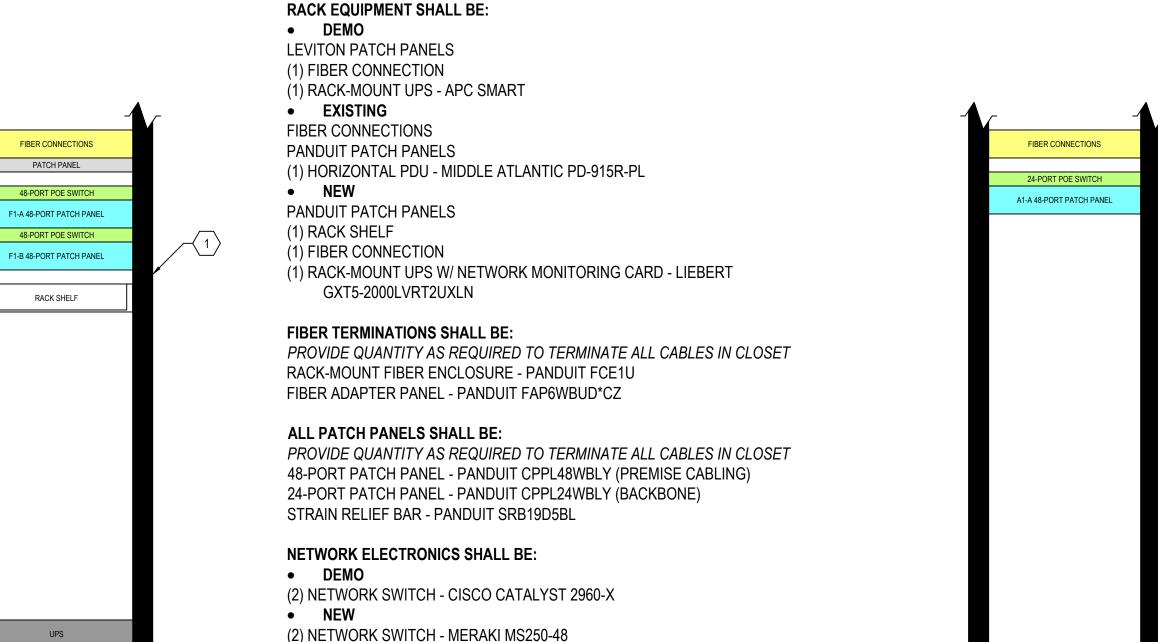

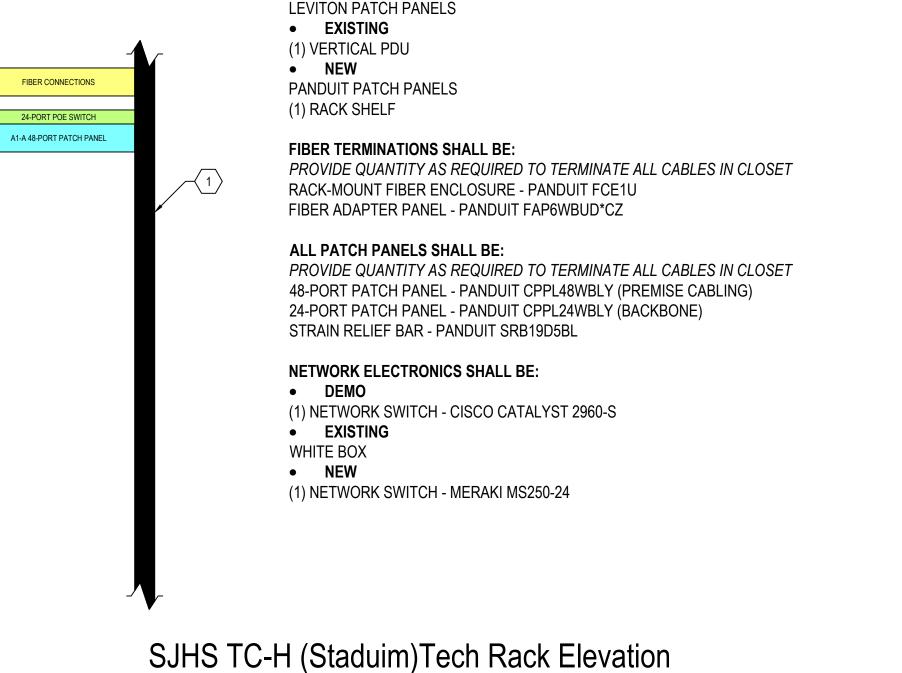

RACK EQUIPMENT SHALL BE:

(1) LEVITON FIBER ENCLOSURE

DEMO

PANDUIT PATCH PANELS NEW PANDUIT PATCH PANELS FIBER CONNECTIONS (1) RACK-MOUNT UPS W/ NETWORK MONITORING CARD - LIEBERT 48-PORT POE SWITCH GXT5-1500LVRT2UXLN J1-A 48-PORT PATCH PANEL FIBER TERMINATIONS SHALL BE: PROVIDE QUANTITY AS REQUIRED TO TERMINATE ALL CABLES IN CLOSET RACK-MOUNT FIBER ENCLOSURE - PANDUIT FCE1U FIBER ADAPTER PANEL - PANDUIT FAP6WBUD*CZ ALL PATCH PANELS SHALL BE: PROVIDE QUANTITY AS REQUIRED TO TERMINATE ALL CABLES IN CLOSET 48-PORT PATCH PANEL - PANDUIT CPPL48WBLY (PREMISE CABLING) 24-PORT PATCH PANEL - PANDUIT CPPL24WBLY (BACKBONE) STRAIN RELIEF BAR - PANDUIT SRB19D5BL **NETWORK ELECTRONICS SHALL BE:** DEMO (1) NETWORK SWITCH - CISCO CATALYST 2960-S NEW (1) NETWORK SWITCH - MERAKI MS250-48 SJHS TC-I Tech Rack Elevation

TECH CLOSET GENERAL NOTES

TECHNOLOGY CLOSETS SHALL BE NON-SPRINKLER SPACES.

GENERAL BUILDING HVAC SHALL NOT BE INSTALLED IN ANY TECHNOLOGY CLOSET. ACTIVE COOLING IS REQUIRED. DEDICATED LOCAL SYSTEMS SHOULD BE INSTALLED

IN EACH TECH CLOSET. ALL OUTLETS IN THE TECHNOLOGY CLOSETS SHOULD BE ON UPS-BACKED,

GENERATOR POWERED CIRCUITS. EQUIPMENT MOUNTED ON BACKERBOARD SHALL MAINTAIN PROPER CLEARANCES

FOR OPERATION AND BE COORDINATED WITH OTHER DISCIPLINES PRIOR TO INSTALL IF THERE IS A CONFLICT OF PLACEMENT. RACK SIZES SHOWN ARE TYPICAL AND MAY NOT MATCH EXISTING RACK SIZES.

ACTUAL EQUIPMENT LAYOUT IN RACKS SHALL FOLLOW EQUIPMENT ORDER SHOWN IN ELEVATIONS, ALONG WITH PROPER LABELING AND CABLE MANAGEMENT. CONFIRM FINAL INSTALL LOCATION WITH OWNER.

DEMOED EQUIPMENT, WHOLE OR IN PART, SHALL BE PRESENTED TO OWNER FOR FIRST RIGHT OF REFUSAL BEFORE REMOVAL FROM SITE.

DEMO ALL ABANDONED EQUIPMENT AND CABLING, INCLUDING COAXIAL. DEMO CABLE TO SOURCE.

DEMO ALL LEVITON PATCH PANELS AND REPLACE WITH PANDUIT PATCH PANELS. DEMO ALL POTS PATCH PANELS, CABLING, ASSOCIATED 110 BLOCKS, AND OTHER

UNUSED POTS EQUIPMENT. DEMO CABLING TO SOURCE. PRIOR TO DEMO, CHECK

FOR DIAL TONE ON ANY LINES. NOTIFY OWNER AND AETD OF ANY DIAL TONE IF

DEMO ALL UPS UNITS.

REMOVE ALL BACKERBOARD-MOUNTED FIBER ENCLOSURES AND RE-INSTALL SPLICED CONNECTORS IN THEIR RESPECTIVE RACK'S FIBER ENCLOSURE.

SEE NETWORK DIAGRAM ON T306 FOR MORE DETAILS ON NETWORK ELECTRONICS AND THEIR LOCATIONS.

RACK-MOUNTED EQUIPMENT SHALL BE INSTALLED WITH ENOUGH CLEARANCE SO THAT THE RACK CAN FUNCTION PROPERLY. PATCH CORDS, POWER CORDS, AND RELATED CABLING SHALL NOT PREVENT DOORS FROM CLOSING, RACK FROM SWINGING, OR OTHER SIMILAR FUNCTIONS.

EXISTING COPPER BACKBONE, PATCH CORDS, JACKS, AND PATCH PANELS TO REMAIN. RELOCATE PATCH PANELS TO THE TOP OF RACKS WHERE POSSIBLE.

TECH CLOSET KEYED NOTES

1 ENCLOSED SERVER RACK.

 \langle 2 \rangle UPS. INSTALL IN BOTTOM OF RACK.

 \langle 4 \rangle MOVE SITESYNC IQ TIME CONTROLLER INTO RACK AT OWNER'S DIRECTION.


(5) (2) EXISTING CONDUITS TO REMAIN


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מ ב Sai Inf Sain ---- Rack

ISSUE / DATE 2023-12-22 BIDS ------------DRAWN BY CDB PROJECT NO.

> SJPS2304-0300 SHEET NO. T304



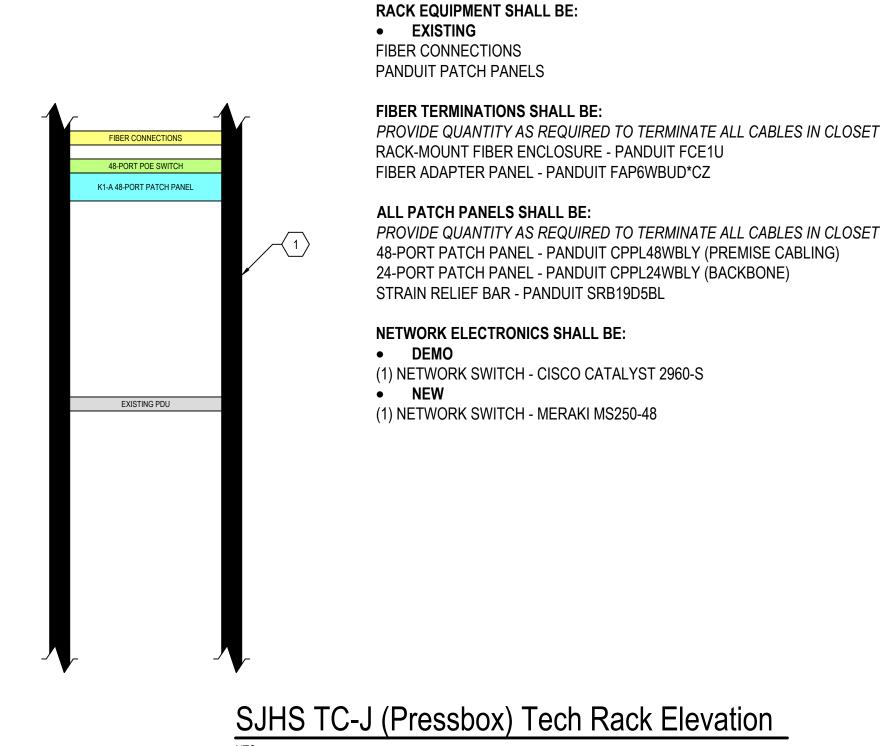

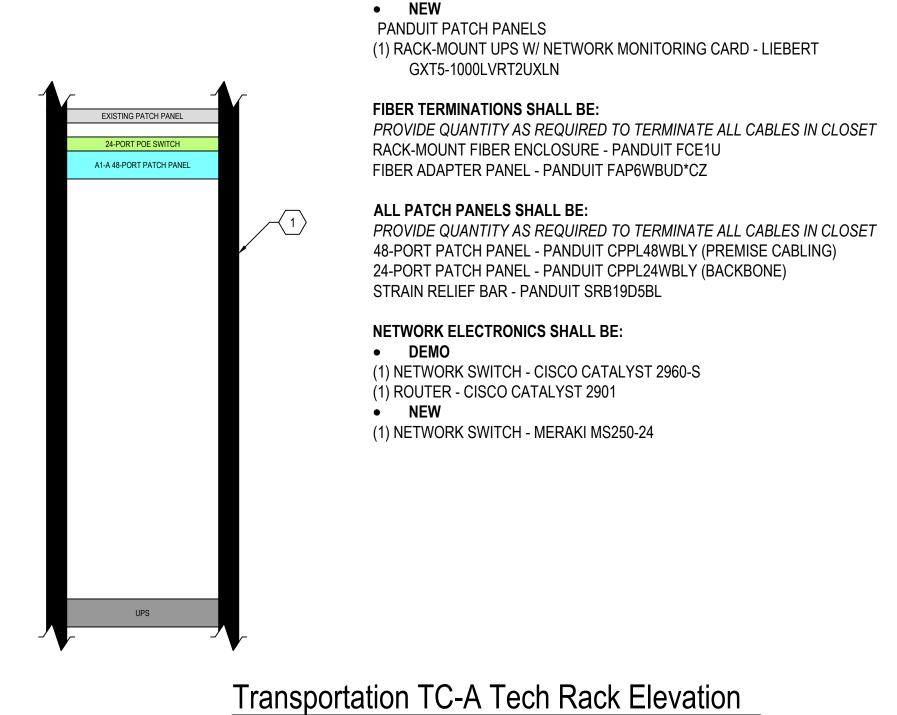 EXISTING PANDUIT PATCH PANELS (1) RACK-MOUNT PDU - APC NEW EXISTING BACKBONE PATCH PANEL PANDUIT PATCH PANELS 48-PORT POE SWITCH (1) RACK SHELF A1-A 48-PORT PATCH PANEL (1) FIBER CONNECTION 48-PORT POE SWITCH (1) RACK-MOUNT UPS W/ NETWORK MONITORING CARD - LIEBERT A1-B 48-PORT PATCH PANEL GXT5-2000LVRT2UXLN FIBER TERMINATIONS SHALL BE: PROVIDE QUANTITY AS REQUIRED TO TERMINATE ALL CABLES IN CLOSET RACK SHELF RACK-MOUNT FIBER ENCLOSURE - PANDUIT FCE1U FIBER ADAPTER PANEL - PANDUIT FAP6WBUD*CZ **ALL PATCH PANELS SHALL BE:** PROVIDE QUANTITY AS REQUIRED TO TERMINATE ALL CABLES IN CLOSET EXISTING PDU 48-PORT PATCH PANEL - PANDUIT CPPL48WBLY (PREMISE CABLING) 24-PORT PATCH PANEL - PANDUIT CPPL24WBLY (BACKBONE) STRAIN RELIEF BAR - PANDUIT SRB19D5BL **NETWORK ELECTRONICS SHALL BE:** DEMO (2) NETWORK SWITCH - CISCO CATALYST 9200L (1) ROUTER - CISCO CATALYST 2901 NEW (2) NETWORK SWITCH - MERAKI MS250-48 UPS

RACK EQUIPMENT SHALL BE:

(1) RACK-MOUNT UPS - ALTRONIX

DEMO

Central Office TC-A Tech Rack Elevation

TECH CLOSET GENERAL NOTES

TECHNOLOGY CLOSETS SHALL BE NON-SPRINKLER SPACES.

- GENERAL BUILDING HVAC SHALL NOT BE INSTALLED IN ANY TECHNOLOGY CLOSET. I ACTIVE COOLING IS REQUIRED, DEDICATED LOCAL SYSTEMS SHOULD BE INSTALLED IN EACH TECH CLOSET.
- ALL OUTLETS IN THE TECHNOLOGY CLOSETS SHOULD BE ON UPS-BACKED,
- GENERATOR POWERED CIRCUITS. EQUIPMENT MOUNTED ON BACKERBOARD SHALL MAINTAIN PROPER CLEARANCES
- FOR OPERATION AND BE COORDINATED WITH OTHER DISCIPLINES PRIOR TO INSTALL IF THERE IS A CONFLICT OF PLACEMENT. RACK SIZES SHOWN ARE TYPICAL AND MAY NOT MATCH EXISTING RACK SIZES.
- ACTUAL EQUIPMENT LAYOUT IN RACKS SHALL FOLLOW EQUIPMENT ORDER SHOWN IN ELEVATIONS, ALONG WITH PROPER LABELING AND CABLE MANAGEMENT. CONFIRM FINAL INSTALL LOCATION WITH OWNER.
- DEMOED EQUIPMENT, WHOLE OR IN PART, SHALL BE PRESENTED TO OWNER FOR FIRST RIGHT OF REFUSAL BEFORE REMOVAL FROM SITE.
- DEMO ALL ABANDONED EQUIPMENT AND CABLING, INCLUDING COAXIAL. DEMO CABLE
- DEMO ALL LEVITON PATCH PANELS AND REPLACE WITH PANDUIT PATCH PANELS.
- DEMO ALL POTS PATCH PANELS, CABLING, ASSOCIATED 110 BLOCKS, AND OTHER UNUSED POTS EQUIPMENT. DEMO CABLING TO SOURCE. PRIOR TO DEMO, CHECK FOR DIAL TONE ON ANY LINES. NOTIFY OWNER AND AETD OF ANY DIAL TONE IF
- DEMO ALL UPS UNITS.
- REMOVE ALL BACKERBOARD-MOUNTED FIBER ENCLOSURES AND RE-INSTALL SPLICED CONNECTORS IN THEIR RESPECTIVE RACK'S FIBER ENCLOSURE.
- SEE NETWORK DIAGRAM ON T306 FOR MORE DETAILS ON NETWORK ELECTRONICS
- AND THEIR LOCATIONS. RACK-MOUNTED EQUIPMENT SHALL BE INSTALLED WITH ENOUGH CLEARANCE SO THAT THE RACK CAN FUNCTION PROPERLY. PATCH CORDS, POWER CORDS, AND

RELATED CABLING SHALL NOT PREVENT DOORS FROM CLOSING, RACK FROM

EXISTING COPPER BACKBONE, PATCH CORDS, JACKS, AND PATCH PANELS TO REMAIN. RELOCATE PATCH PANELS TO THE TOP OF RACKS WHERE POSSIBLE.

TECH CLOSET KEYED NOTES

1 ENCLOSED SERVER RACK.

 \langle 2 \rangle UPS. INSTALL IN BOTTOM OF RACK.

SWINGING, OR OTHER SIMILAR FUNCTIONS.


 \langle 4 \rangle MOVE SITESYNC IQ TIME CONTROLLER INTO RACK AT OWNER'S DIRECTION.


 $\left\langle 5 \right\rangle$ (2) EXISTING CONDUITS TO REMAIN


Tech Rack Elevations

DRAWN BY CDB

PROJECT NO. SJPS2304-0300

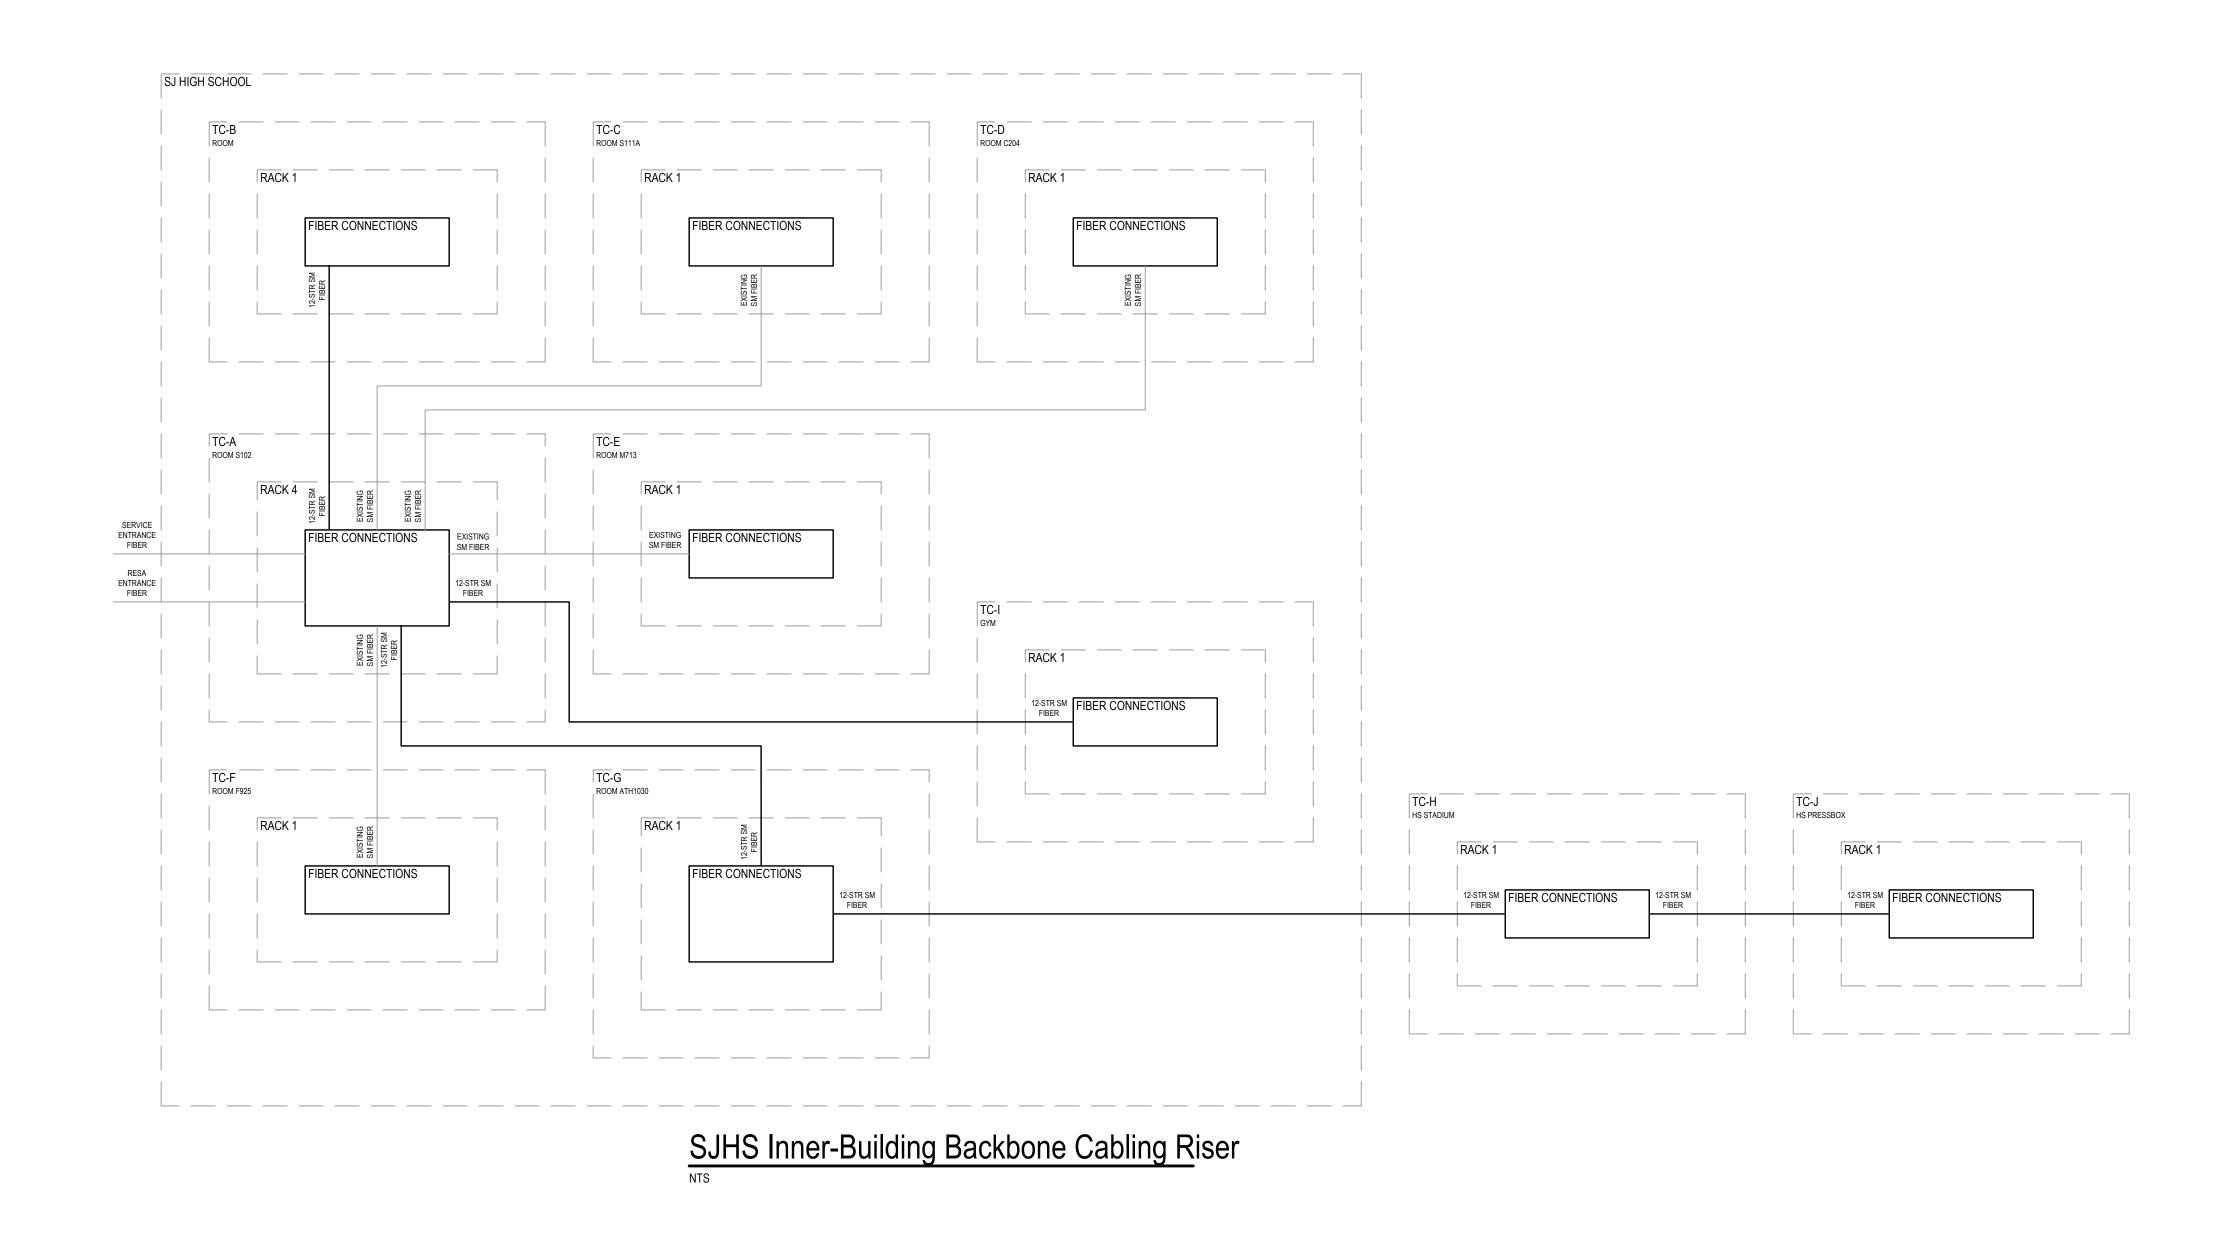

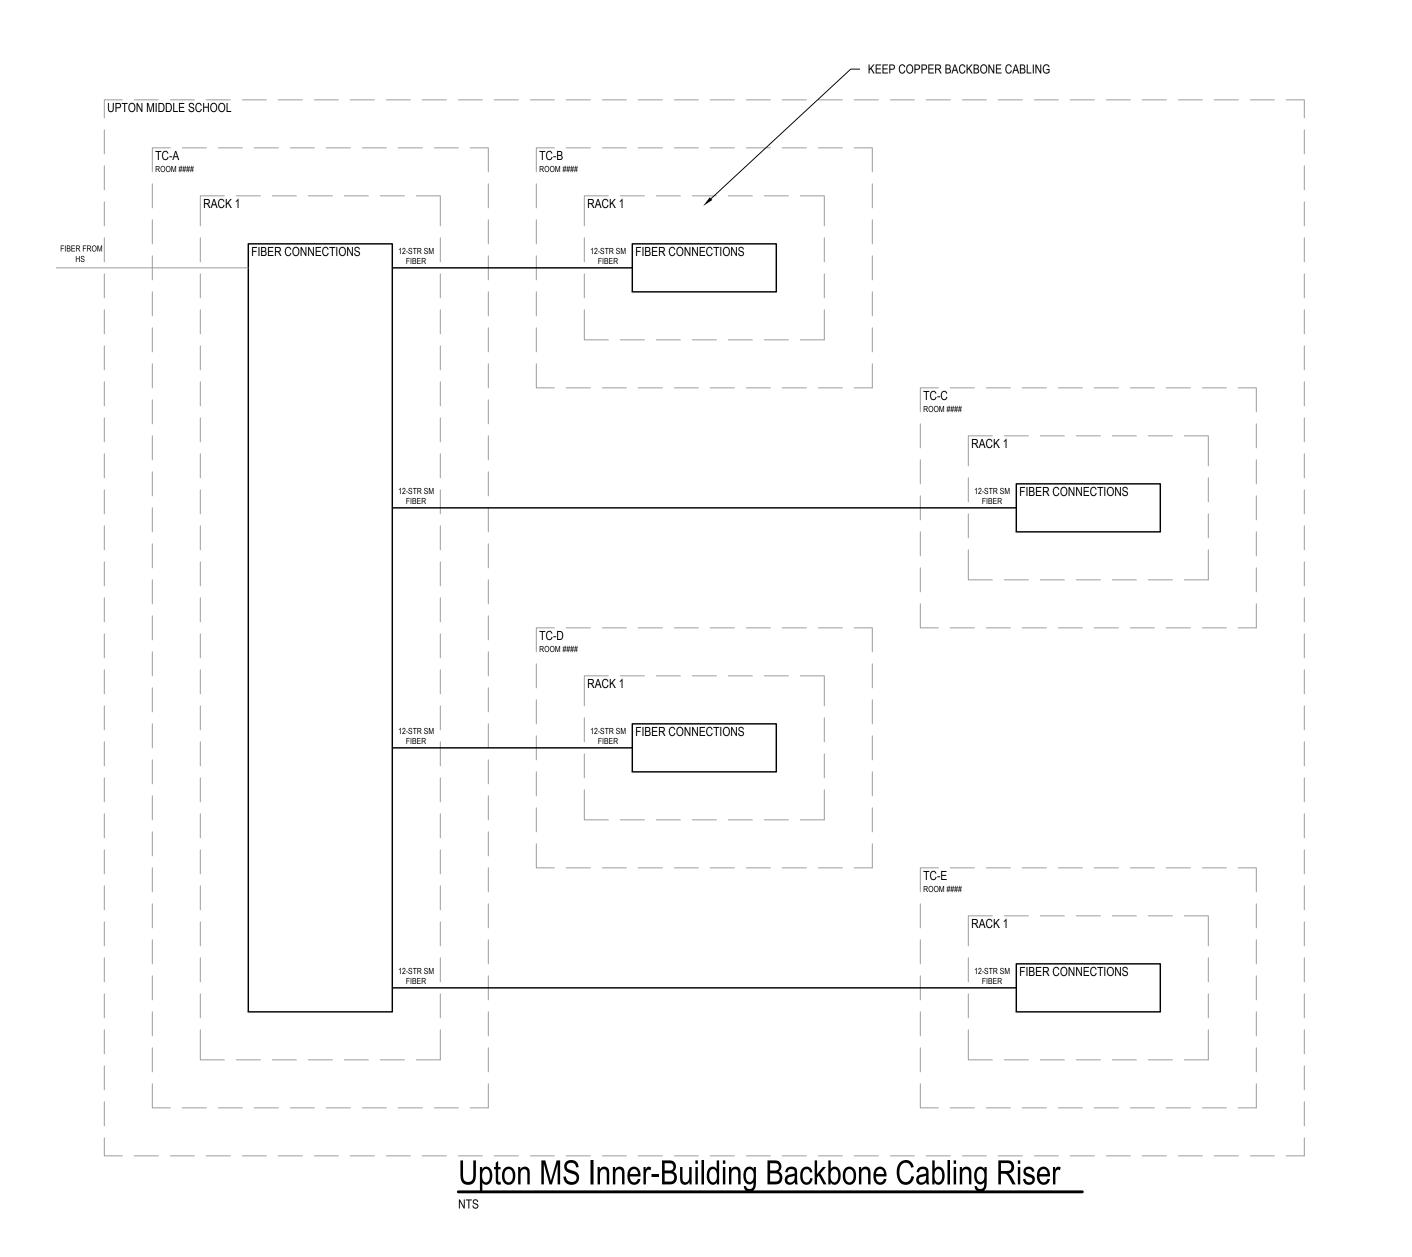

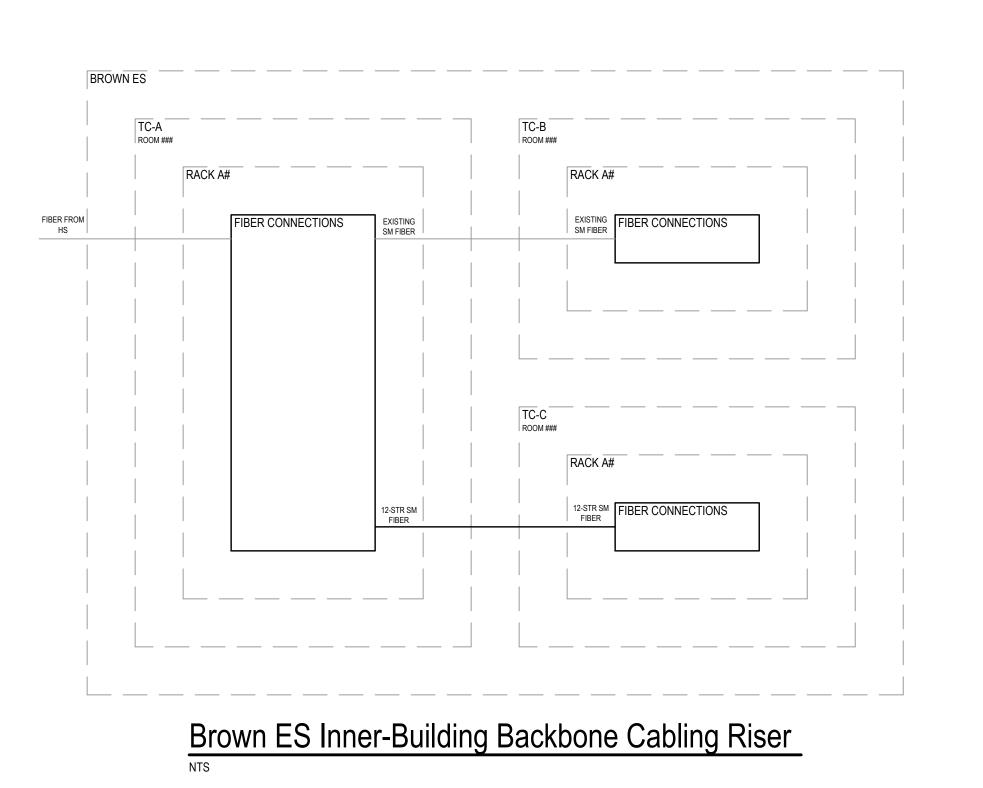

CABLING DISTRIBUTION NOTES

- 1. PROVIDE 10 FEET OF MAINTENANCE LOOP AT TECHNOLOGY ROOM AND 1 FOOT OF MAINTENANCE LOOP AT WORK AREA FOR ALL CABLING UNLESS NOTED OTHERWISE.
- 2. FOR EACH RUN OF BACKBONE FIBER BETWEEN TECHNOLOGY ROOMS, TERMINATE 2
- STRANDS. TEST ALL STRANDS.

 SEE PATCH CORD LEGEND AND CABLING AND JACK LEGEND ON TG02 FOR MORE INFORMATION REGARDING APPROPRIATE COLORS REQUIRED.
- BACKBONE RISERS ARE ONLY SHOWN FOR BUILDINGS WHERE INNER-BUILDING BACKBONES ARE BEING REPLACED.
- 5. COPPER BACKBONE CABLING, PATCH CORDS, PATCH PANELS, AND JACKS TO REMAIN.

GROUNDING NOTES

ENSURE ALL GROUNDING CONNECTIONS TO RACKS AND CABLETRAYS ARE MAINTAINED.

6100 NEWPORT ROAD, SUITE #225, PORTAGE, MI 49002: 269-203-2444 · AETECH. DESIGN


ablina Details & Riser


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ISSUE / DATE
2023-12-22 BIDS


DRAWN BY
CDB
PROJECT NO.


SJPS2304-0300 SHEET NO.




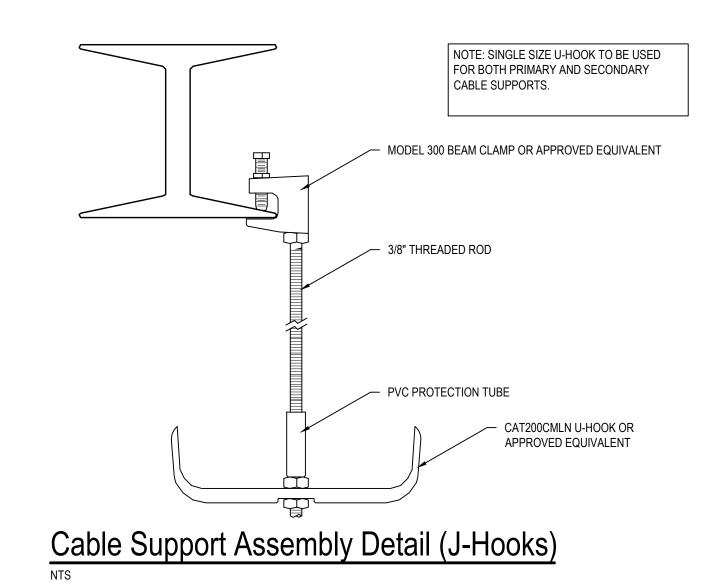

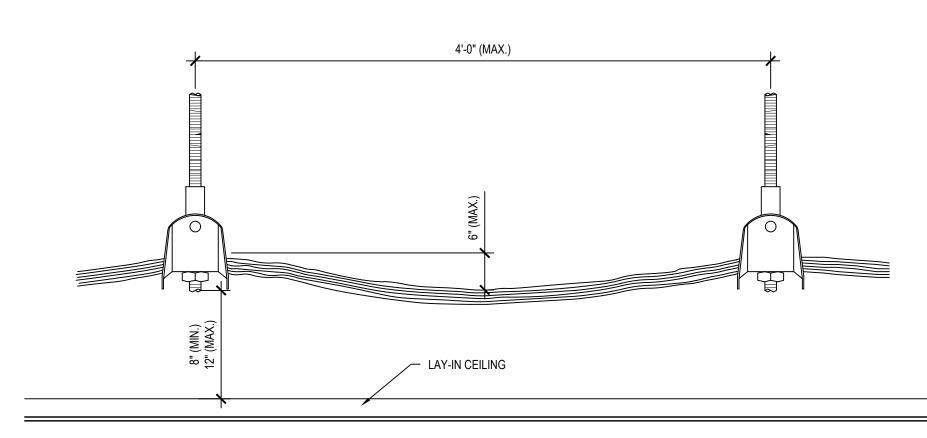Cable Support Installation Detail (J-Hooks)

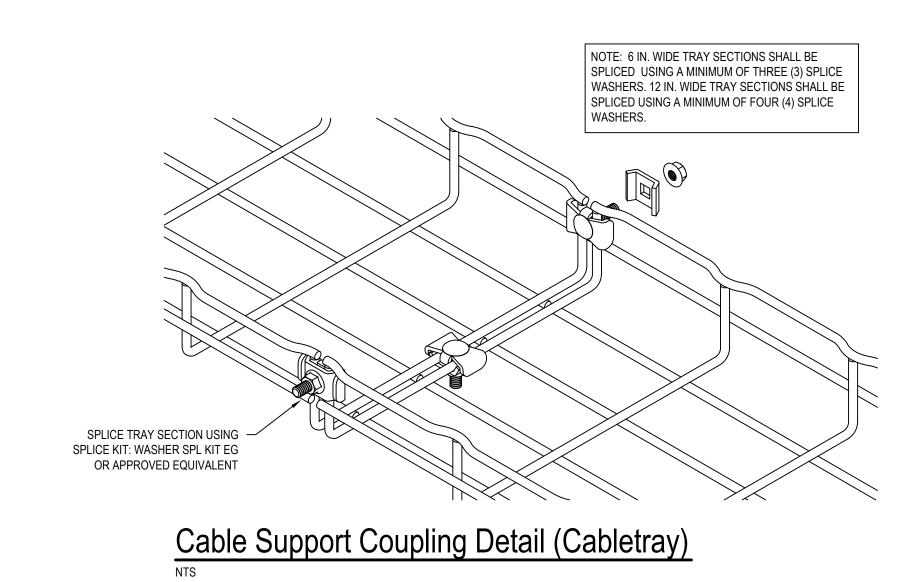

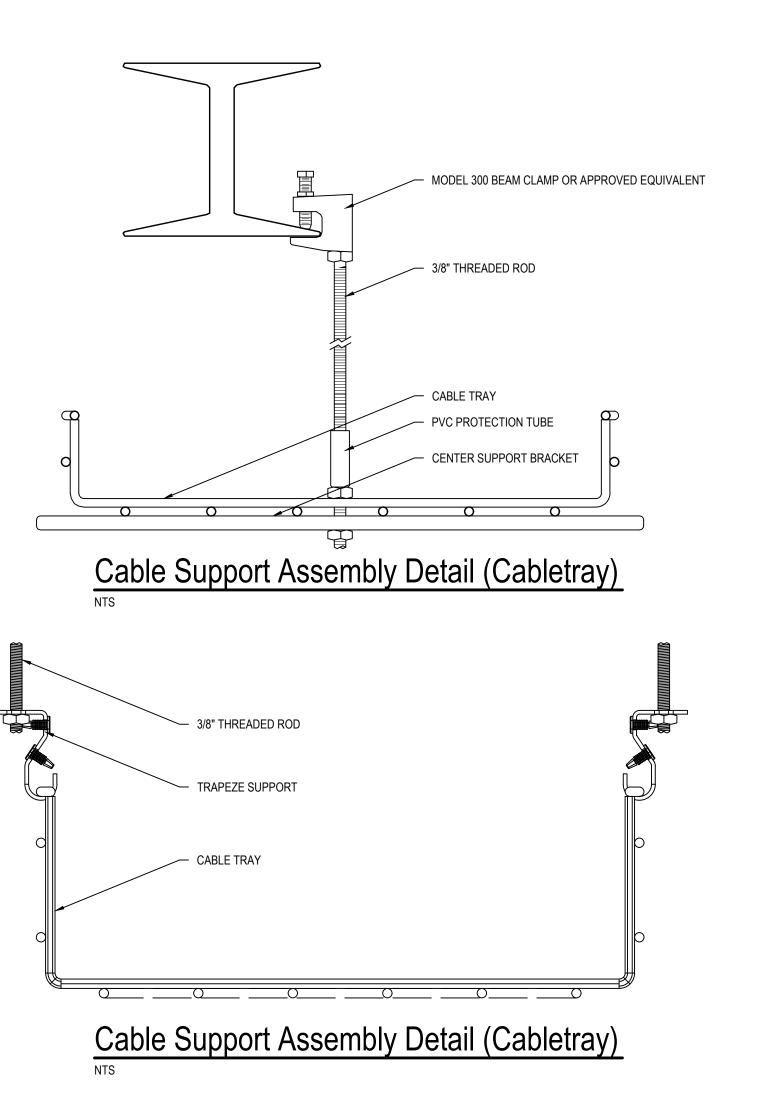

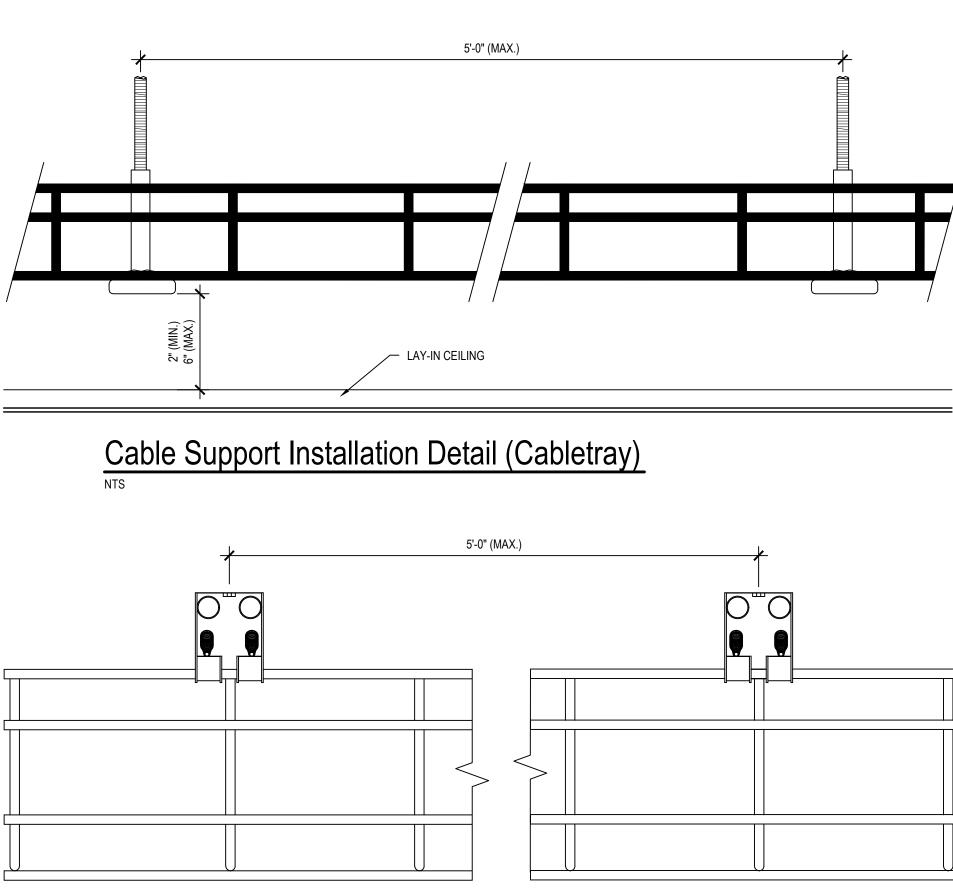


DRAWN BY CDB PROJECT NO. SJPS2304-0300 SHEET NO. Cable Support Installation Detail (Cabletray)

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Saint Joseph Public Schools Infrastructure Upgrades Saint Joseph, MI

Structured Cabling Support Information



Diagram

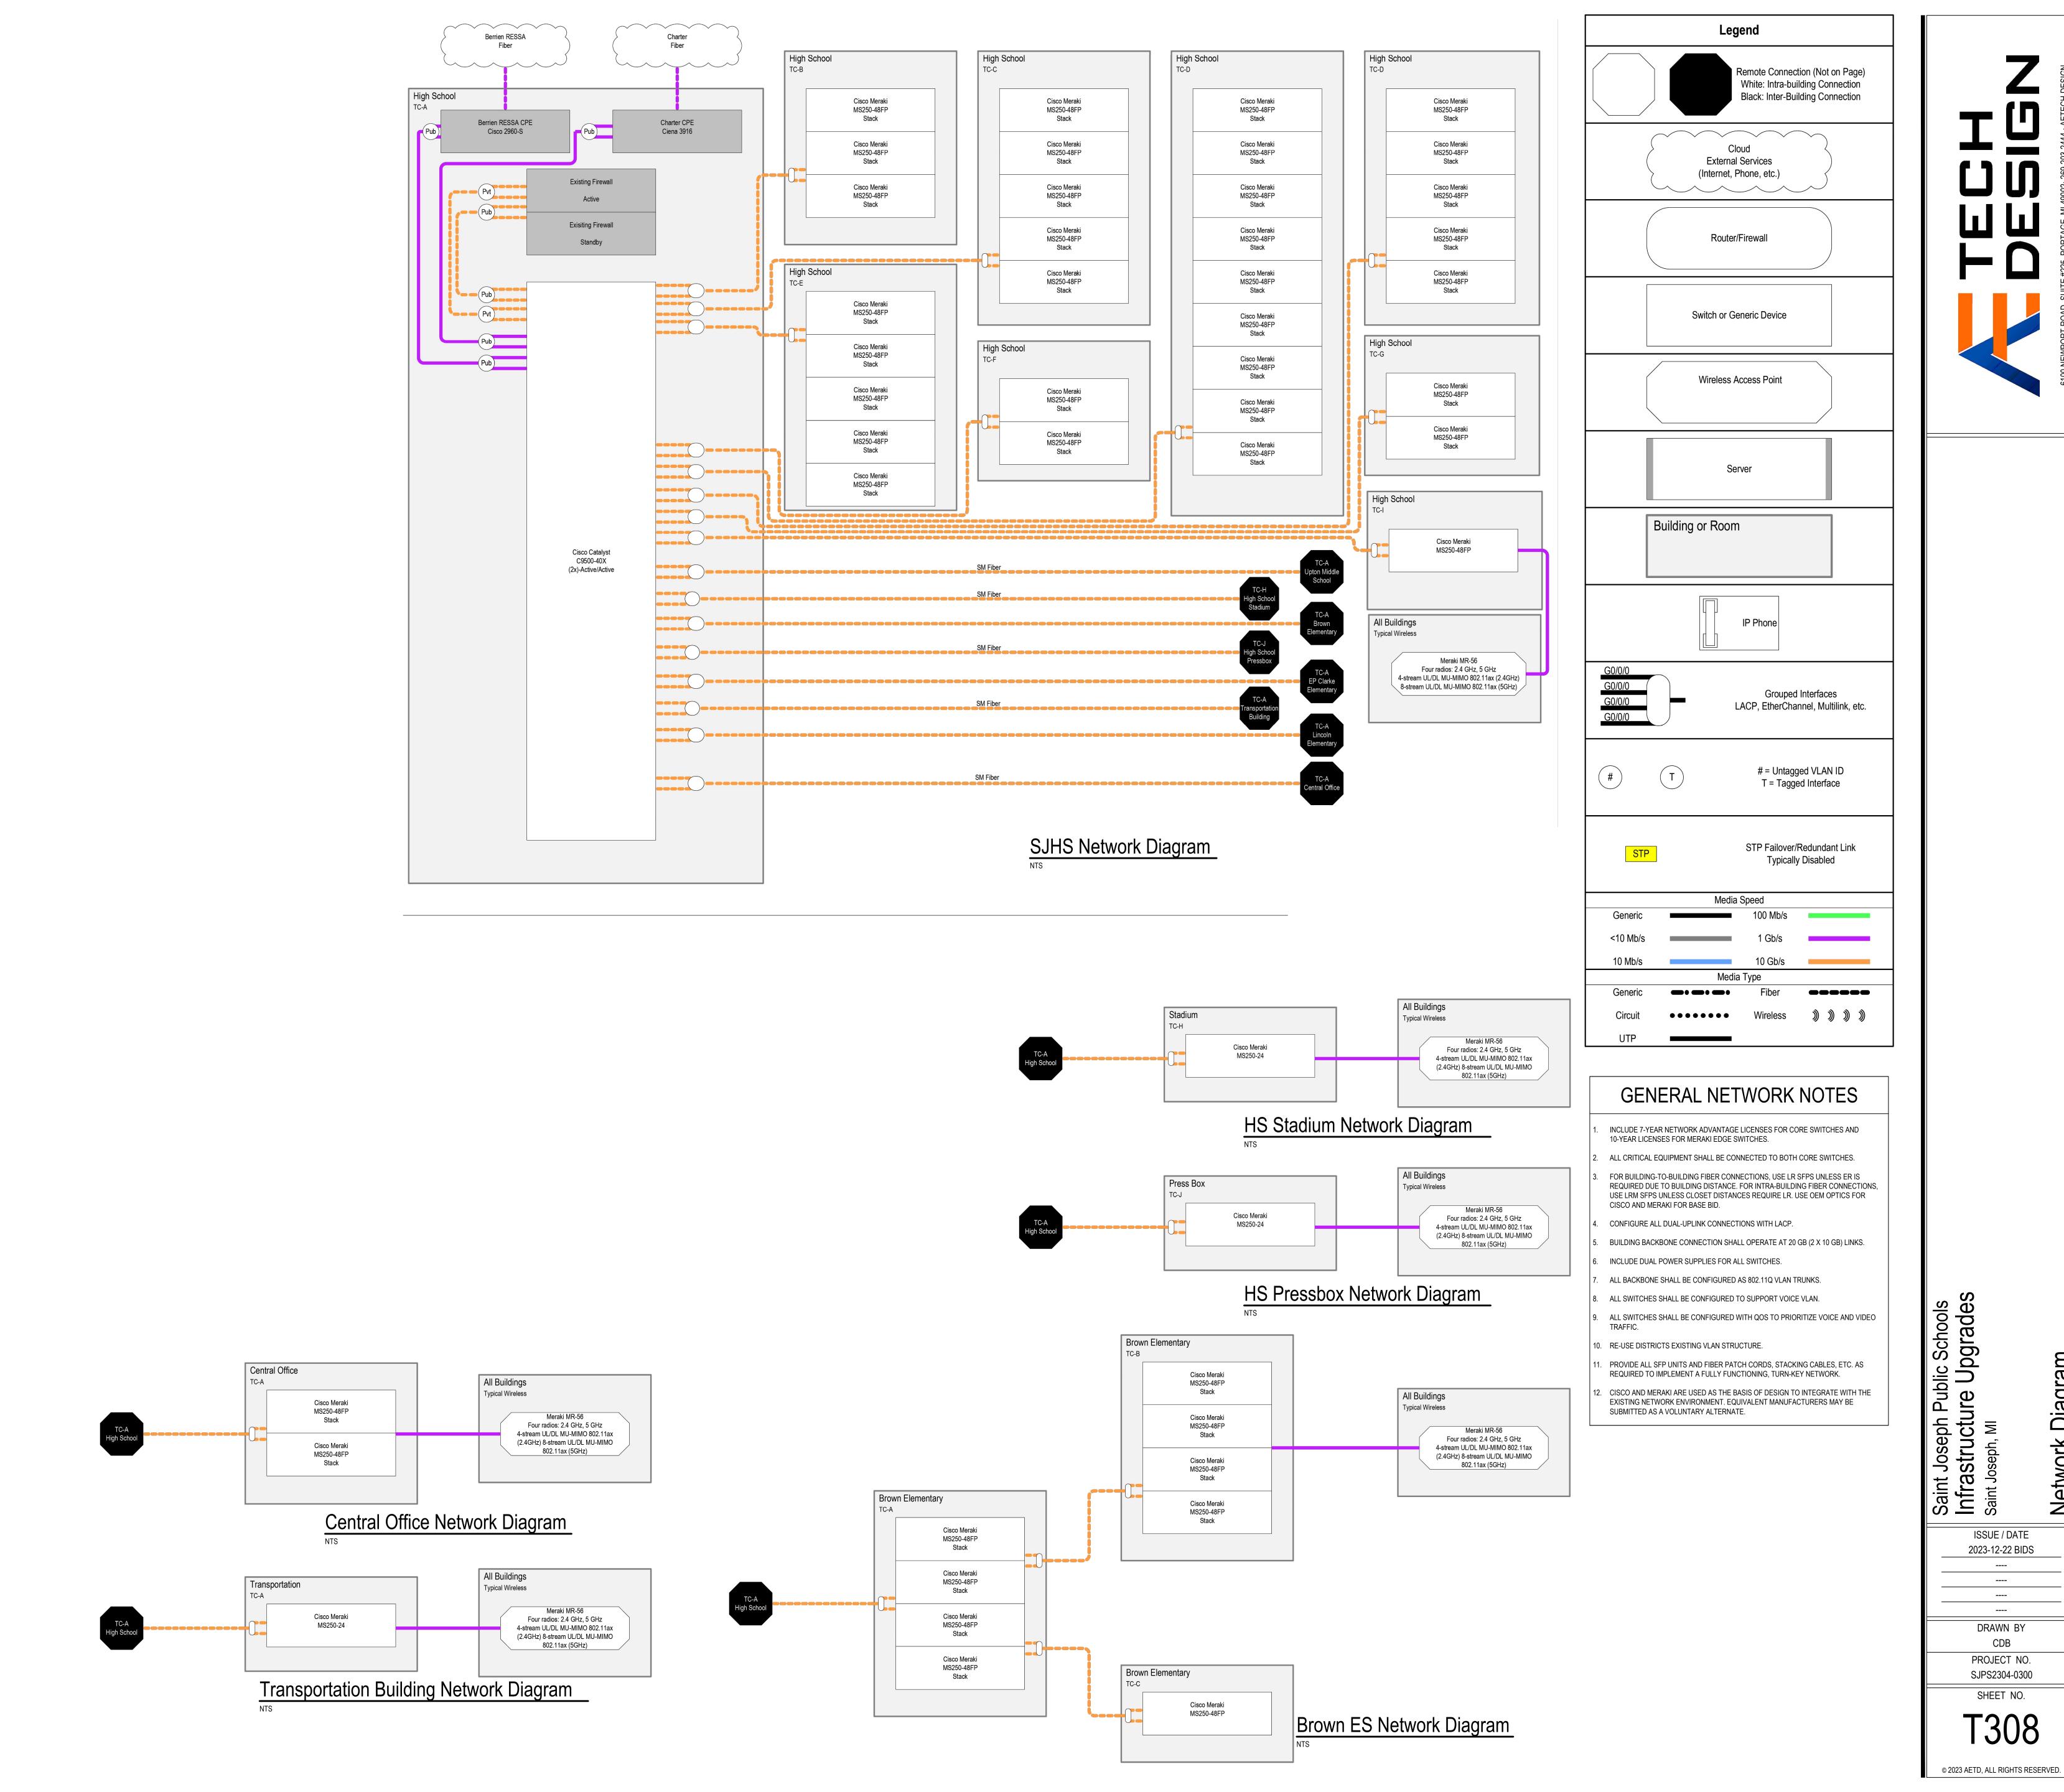Network